
SCHMITT & MALAVOLTA RESIDENCE

MARGARET SCHMITT & MARC MALAVOLTA 1030 HERSHEY MILL ROAD WEST CHESTER, PA 19380

EAST GOSHEN TOWNSHIP - CHESTER COUNTY

KITCHEN RENOVATION

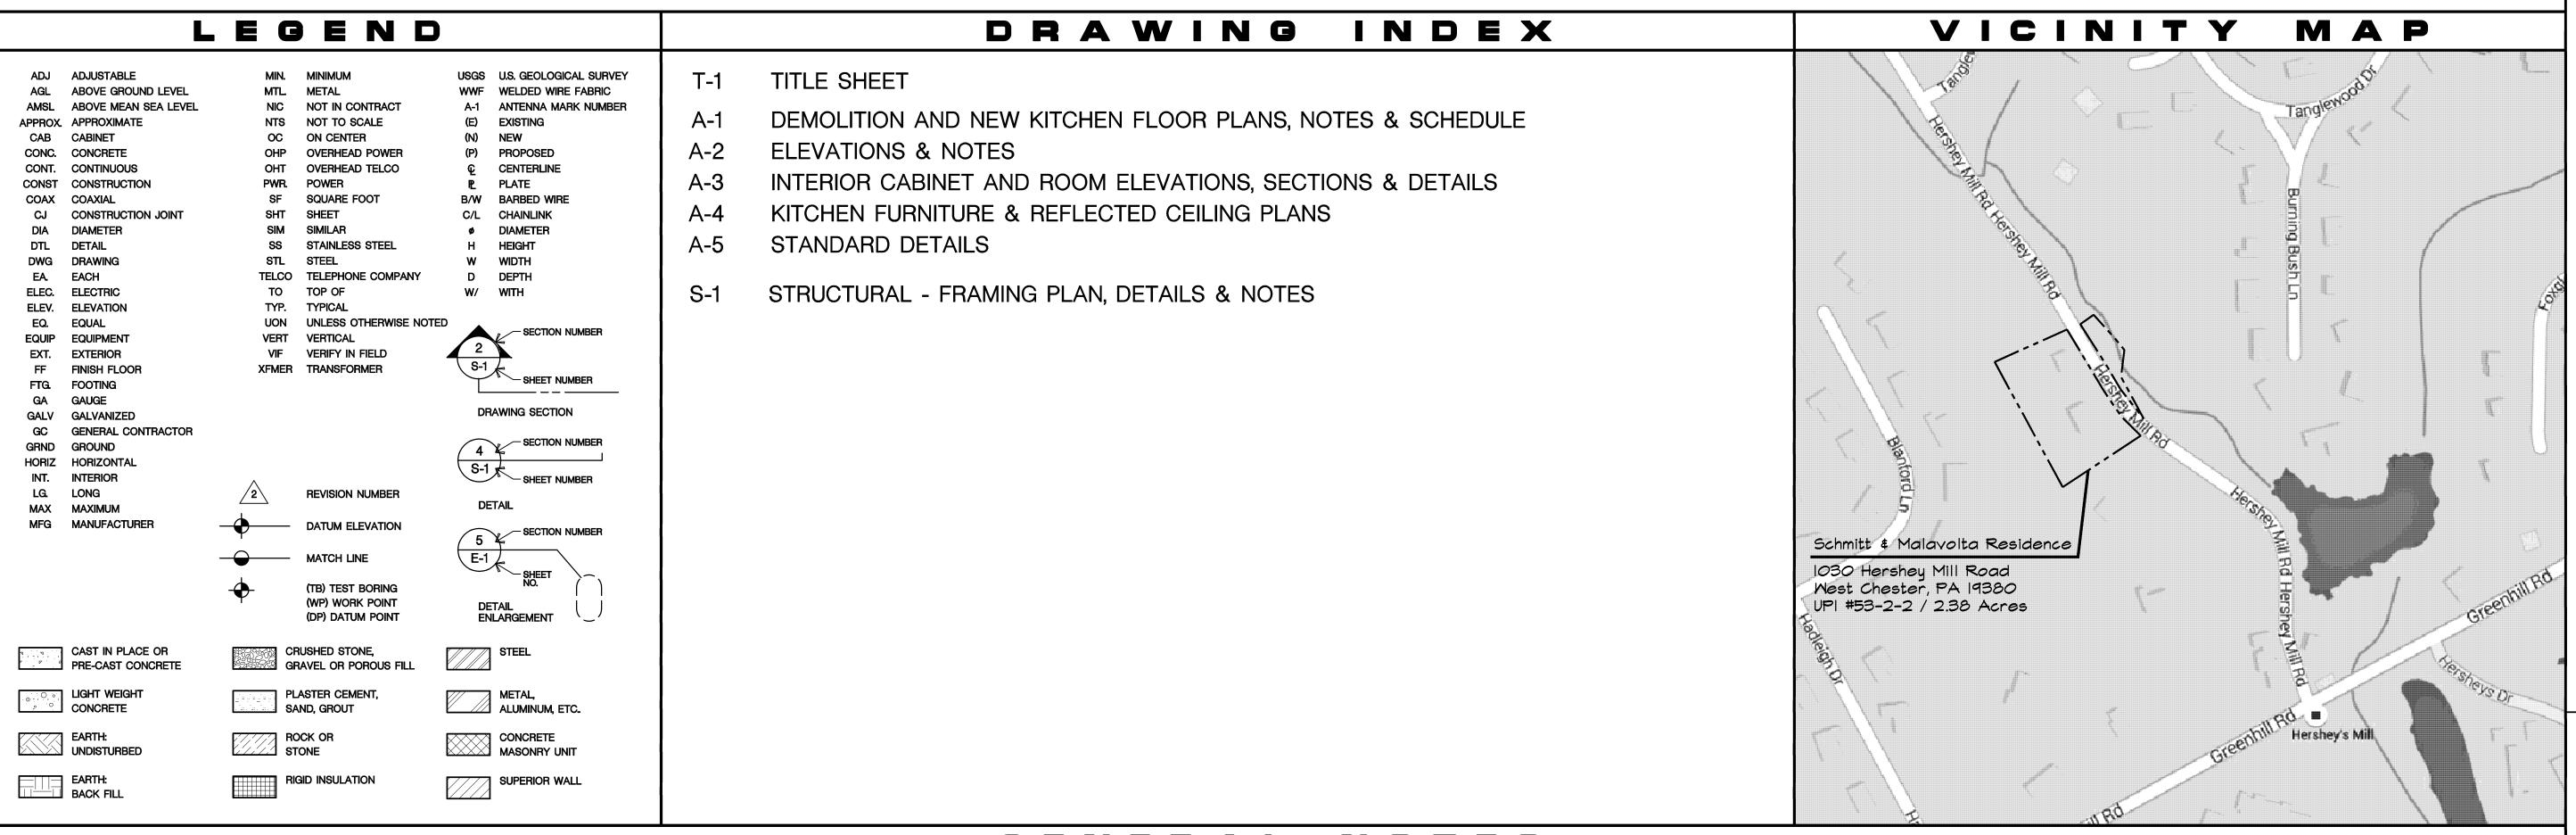

GENERAL NOTES

ADOPTED BY EAST GOSHEN TOWNSHIP IN THE COMMONWEALTH OF PENNSYLVANIA. CONTRACTOR TO HAVE ALL REQUIRED LOCAL LICENSES.

ALL WORK SHALL BE DONE IN ACCORDANCE WITH THE LATEST EDITION OF THE 2009 IRC CODE

- GENERAL CONTRACTOR SHALL VERIFY ALL EXISTING DIMENSIONS, STRUCTURE AND MATERIALS, AND SHALL BRING ANY DISCREPANCIES TO THE IMMEDIATE ATTENTION OF THE ARCHITECT.
- CONTRACTOR TO HAVE INSURANCE AS REQUIRED BY OWNER.
- THE USE OF THE PENNSYLVANIA ONE-CALL SYSTEM, INC. IS REQUIRED PRIOR TO ANY EXCAVATION. COORDINATE RELOCATION OF UTILITIES AS REQUIRED.
- FOLLOWING NOTES ARE MINIMUM STANDARDS FOR THE PROJECT. ALL NOTES ON DRAWINGS SUPERSEDES ALL COVER SHEET GENERAL NOTES.
- PROVIDE PORTABLE JOB TOILET AND TELEPHONE ON SITE FOR THE DURATION OF THE PROJECT. (AS required by owner).
- RELOCATION OF ANY EXISTING TREES AND SHRUBS TO BE BY OWNER, FINAL GRADING AND LANDSCAPING TO BE PROVIDED BY OWNER.
- PROVIDE EXCAVATION AS REQUIRED BY DRAWINGS. SOIL BEARING STRENGTH TO BE MINIMUM 3000
- CONTRACTOR TO LAYOUT PARTITIONS AND ALL ROUGH OPENINGS FOR ARCHITECT/OWNER TO REVIEW 19) FOR DESIGN INTENT. DO NOT PROCEED WITH INSTALLATION OF STUDS WITHOUT THIS REVIEW APPROVAL. CONTRACTOR SHALL COORDINATE AND VERIFY CONDITIONS TO ENSURE PROPER FIT. REVIEW FOR DESIGN INTENT DOES NOT RELEASE CONTRACTOR FROM THE RESPONSIBILITY TO MAINTAIN CRITICAL DIMENSIONS AND CLEARANCES.
- 10) NO BACKFILLING OR ROUGH GRADING SHALL BE DONE UNTIL THE FIRST FLOOR DECK IS COMPLETELY INSTALLED.

- ALL DIMENSIONS ARE TO ROUGH STUD FACE, CONCRETE OR C.M.U. FACE, AND EXTERIOR SHEATHING FACE (U.N.O.).
- COORDINATE FINISH WALL DIMENSIONS WITH MILLWORK AND FURNITURE SYSTEM DIMENSIONS AS REQUIRED.
- REMOVE ALL CONSTRUCTION DEBRIS FROM PROPERTY AND PROVIDE DAILY CLEANUP TO SITE
- CONTRACTOR TO PROVIDE FINAL GRADING AND GRADE EARTH AWAY FROM FROM ALL PARTS OF NEW CONSTRUCTION AND MAINTAIN 8" (MIN) DISTANCE FROM TOP OF FINAL GRADE TO WOOD WALL FRAMING.
- VERIFY WITH OWNER CONSTRUCTION STAGING AND CONSTRUCTION DELIVERY LOCATIONS.
- GUTTERS AND DOWNSPOUTS ETC. AS REQUIRED TO PREVENT THE ENTRANCE OF MOISTURE AND WATER.

PROVIDE ALL WALL, BASE, CAP, THROUGH-WALL, DIVERTER FLASHING, COUNTER FLASHINGS,

- BUILDING SHALL BE SHEATHED WITH (MIN.) WEATHER RESISTIVE BARRIER AND 15# ASPHALT-IMPREGNATED FELT.
- WINDOW SIZES ARE BASED UPON ANDERSON 400 SERIES WINDOWS. ALL GLAZING OVER 9 SQUARE FEET AND/OR WITHIN 18" OF FLOOR AND IN HAZARDOUS LOCATIONS SHALL BE TEMPERED.
- METAL HEAD FLASHING SHALL BE INSTALLED IN ALL WINDOWS. MINIMUM 6" WIDE FLASHING TAPE SHALL BE INSTALLED AROUND ALL WINDOWS. FOLLOW ALL MANUF. RECOMMENDATION.
- MIDPOINT WITH SOLID BLOCKING. 21) INTERIOR PARTITIONS SHALL RECEIVE 1/2" (MIN.) GYPSUM DRYWALL. GARAGE WALLS AND CEILINGS SHALL RECEIVE 5/8" (TYPE"X") FIRE RATED GYPSUM DRYWALL.

20) ALL STUD FRAMED WALLS GREATER THAN 8'-6" VERTICALLY SHALL BE LATERALLY BRACED AT THE

- 22) ALL NEW WOODWORK TO BE PAINT GRADE FINGER JOINTED PINE (UNO) INSTALLED. SANDED AND READY 32) FOR FINISH. VERIFY WITH OWNER BEFORE PURCHASE, ANY SUBSTITUTIONS IN FINISH WOODWORK
- 23) PROVIDE ALL REQUIRED CEMENTIOUS BACKER-BOARD AS REQ'D AT ALL AREAS OF MARBLE/GRANITE/
- 24) VERIFY ALL FLOORING HARDWOOD, TILE & CARPETING AND PADDING WITH OWNER. PROVIDE SAMPLES AS REQUIRED. 25) FILL, SPACKLE (3-COATES), SAND AND PRIME/PAINT ALL NEW DRYWALL WORK IN PREPARATION FOR

MATERIALS, (IE HARD WOODS, STAIN GRADE, ECT.).

- FINAL FINISH. 26) PAINT TO BE SHERWIN WILLIAMS OR APPROVED EQUAL, ACRYLIC LATEX. ALL NEW AND EXISTING
- SURFACES TO RECEIVE ONE COAT PRIMER AND MINIMUM 2 COATS FINISH. 27) ALLOW A MINIMUM OF 8" BETWEEN THE TOP OF FOUNDATION AND GRADE AND A MINIMUM OF 6" BETWEEN FINISH GRADE AND SHEATHING OR SIDING.
- 28) PORTLAND CEMENT STUCCO SHALL CONSIST OF (3 COATS) SCRATCH, BROWN AND FINISH COATS (MIN 7/8" THK.) APPLIED OVER (MIN.) 2.4 SELF FURRING GALV. WIRE LATH AND TWO LAYERS OF 30# ASPHALT-IMPREGNATED FELT.
- 29) MASONRY AND STONE VENEERS SHALL BE ANCHORED TO SHEATHING WITH GALVANIZED CORRUGATED METAL TIES AT 32" O.C. HORIZONTALLY AND 16" O.C. VERTICALLY. FLASHING SHALL EXTEND BELOW MASONRY OR STONE AT ALL SILLS: WEEP HOLES SHALL BE PROVIDED AT 21-0" O.C. AT BASE OF CAVITY AND 6" ABOVE GRADE.
- 30) NO STRUCTURAL CHANGES SHALL BE MADE WITHOUT PRIOR APPROVAL BY THE ARCHITECT / ENGINEER.
- ALL SMOKE & CARBON MONOXIDE DETECTORS SHALL BE INTERCONNECTED. ALL DETECTORS SHALL HAVE A PRIMARY 120 VOLT SUPPLY AND A SECONDARY SYSTEM CONSISTING OF A BATTERY BACK-UP.

ELECTRICAL CONTRACTOR TO BE LICENSE AND INSURANCE WITH THE LOCAL MUNICIPALITY AND THE


- STATE AS REQUIRED. ELECTRICAL CONTRACTOR TO OBTAIN ALL PERMITS. ELECTRICAL CONTRACTOR TO VERIFY CAPACITY OF INCOMING SERVICE TO SERVE THE NEW SPACES/ROOMS AS INDICATED. PROVIDE ALL ATTENDANT WIRING, PANELS, ETC., AS REQ'D.
- 34) ELECTRICAL CONTRACTOR TO VERIFY FINAL NO., STYLE, COLOR, TYPES AND LOCATIONS OF ALL OUTLETS, SWITCHES, FIXTURES, ETC., WITH OWNER PRIOR TO ORDERING/INSTALLATION.
- ALL MECHANICAL WORK TO BE DESIGN BUILD, MECHANICAL CONTRACTOR TO BE LICENSE AND INSURANCE WITH THE LOCAL MUNICIPALITY AND THE STATE AS REQUIRED. HVAC CONTRACTOR TO OBTAIN ALL PERMITS. OWNER TO APPROVE ALL NEW GRILLE LOCATIONS AND STYLES PRIOR TO INSTALLATION (INCLUDING ALL ATTENDANT EQUIPMENT LOCATIONS).
- 36) PLUMBING CONTRACTOR TO BE LICENSE AND INSURANCE WITH THE LOCAL MUNICIPALITY AND THE STATE AS REQUIRED. PLUMBING CONTRACTOR TO OBTAIN ALL PERMITS.
- PLUMBING CONTRACTOR TO EXTEND ALL PLUMBING LINES AS REQUIRED FOR ALL FIXTURES. SCOPE OF WORK TO INCLUDE ALL HOT AND COLD WATER FEEDS, WASTE PIPES OUT, STACK & VENTS, SETTING OF FIXTURES, GAS PIPING AND ANY AND ALL HOOK-UPS/TIE-INS AS REQUIRED.

523 Kimberton Road, Suite 11B Phoenixville, PA 19460 tel. (610) 917-8831 fax (610) 917-8836

email mail@betzwood.com

Robin J. Kohn, AlA Commonwealth of Pennsylvania License No. RA-11327-X

> Contact Person: Edward (Kipp) Happ (610) 917-8831

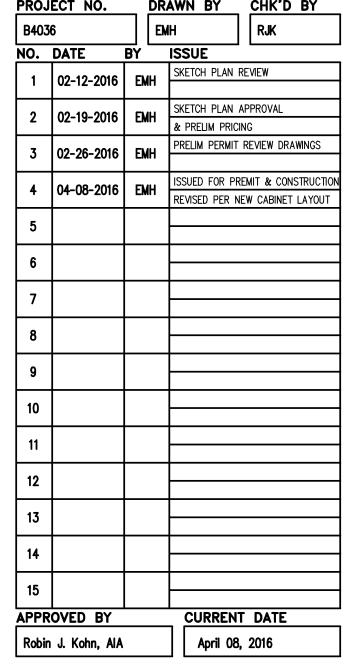

Schmitt & Malavolta Residence

1030 Hershey Mill Road West Chester, PA 19380

East Goshen Township **Chester County**

SHEET TITLE

TITLE SHEET

SHEET NUMBER

DEMOLITION NOTES

- REMOVE ALL CABINETS AND APPLIANCES IN THERE ENTIRETY. SALVAGE DISHWASHER FOR REUSE IN THE NEW KITCHEN DESIGN.
- 2 REMOVE BATHROOM FIXTURES IN THERE ENTIRETY. SALVAGE SINK FOR REUSE IN THE REMOVE BATHROOM FIXTURES IN THERE
- REMOVE EXISTING CEILING PLASTER / 3 REMOVE EXISTING CEILING PLASTER , DRYWALL INCLUDING LOOSE FILLED INSULATION IN THERE ENTIRETY.

NEW POWDER ROOM DESIGN.

- MATCH EXISTING THICKNESS.
- REMOVE EXISTING WALL PLASTER/ DRYWALL INCLUDING ANY INSULATION IN THERE ENTIRETY.
- FEMOVE EXISTING FLOORING FINISH AND SUBFLOOR IN THERE ENTIRETY.
- REMOVE WINDOW IN IT'S ENTIRETY TO ACCOMMODATE NEW WORK. PATCH WALLS TO 2. REMOVE ALL EXISTING HOT WATER CAST IRON
- 7 RELOCATE WINDOW TO ACCOMMODATE NEW KITCHEN LAYOUT.
- REMOVE INTERIOR WALLS AS SHOWN IN 8 THERE ENTIRETY, TEMPORARY SUPPORT BEARING WALLS UNTIL NEW STRUCTURE IS IN
- 9 MOVE EXISTING WASTE LINE VENT / CLEANOUT AS SHOWN ON 2/A-1

CONSTRUCTION NOTES

ARE BEING REMOVED. INSTALL NEW SUPPORT

FOOTING BEARING FOR POSTS PRIOR CLOSER

BEAM AND POSTS. VERIFY FOUNDATION \$


OF NEW SUBFLOOR PLYWD.

- REMOVE EXISTING KITCHEN SINK BASE
 CAREFULLY TO SETUP A TEMPORARY KITCHEN. 5. POUR NEW CONCRETE SLAB / MOISTURE LOCATION TO BE DETERMINED BY HOME BARRIER AND INSTALL TEG SUBFLOOR PLYWD. 6. TEMPORARY SUPPORT BEARING WALLS THAT
- RADIATORS. REPLACE WITH LOWER PROFILE BASERAY CAST IRON UNIT(S) AS DIRECTED BY ARCHITECT / HOME OWNER. 3. REMOVE EXCESSIVE SOILS FROM UNDER
- 7. REMOVE EXISTING PLUMBING CHASE AND RELOCATE SANITARY TO THE EXTERIOR WALL FLOOR JOIST TO ACCOMMODATE NEW MOISTURE BARRIER & CONCRETE SLAB AND WATER LINES RELOCATE TO NEW INTERIOR POWDER ROOM WALL. INSULATE (NOTIFY ARCHITECT OF ANY FOUNDATION ALL WATER LINES THAT ARE EXPOSED. DETERIORATION.)
- 8. ALL EXPOSED WOOD (BEAMS & FLOORING) 4. REPAIR ANY DAMAGE TO EXIST JOISTS BY SHALL BE RECLAIMED FIR/HEART PINE AND SISTERING NEW 2× FRAMING TO ONE SIDE. (NOTIFY ARCHITECT OF ANY AND ALL TO MATCH EXISTING. STRUCTURAL DETERIORATION.)

MOULDING PROFILES									
# 	\$\frac{\infty}{4}	11 Z	VARIES *						
BASE BOARD • IX8 MOP BOARD • I ½" BASE CAP • ¾" QTR ROUND	DOOR & WINDOW CASING IX4 BEADED CASING BACK BAND	WAINSCOT CAP CHAIR RAIL CAP ¼"THK BEAD BOARD	WINDOW SILL • 1/4 STOOL						

ROOM FINISH SCHEDULE											
FLOOR HE CEILING				HEIGHT	EIGHT REMARKS		MATERIAL CODE				
100 - KITCHEN	1	Α	1	7'-10"	FAUX BEAMS	Fl	_R. / BASE		WALL		CEILING
101 - BREAKFAST RM	1	Α	1	7'-10"	FAUX BEAMS	1	R.WD/WD	Α	G.W.B.	ı	G.W.B.
102 - POWDER RM	1	B/A	2	7'-9"	GWB UPPER	2	T / WD	В	WD. WAINSCOT	2	WD PAINTE
						MATERIAL GLOSSARY					
						G.W.B. GYPSUM WALL BO R.WD RECLAIMED WOOD T TILE WD. WOOD					

HISTORIC PRESERVATION PERCENTAGE OF FACADE ALTERATIONS								
CLASS II STRUCTURE								
PERCENTAGE								
NO CHANGE								
LESS THAN 20%								
LESS THAN 15%								

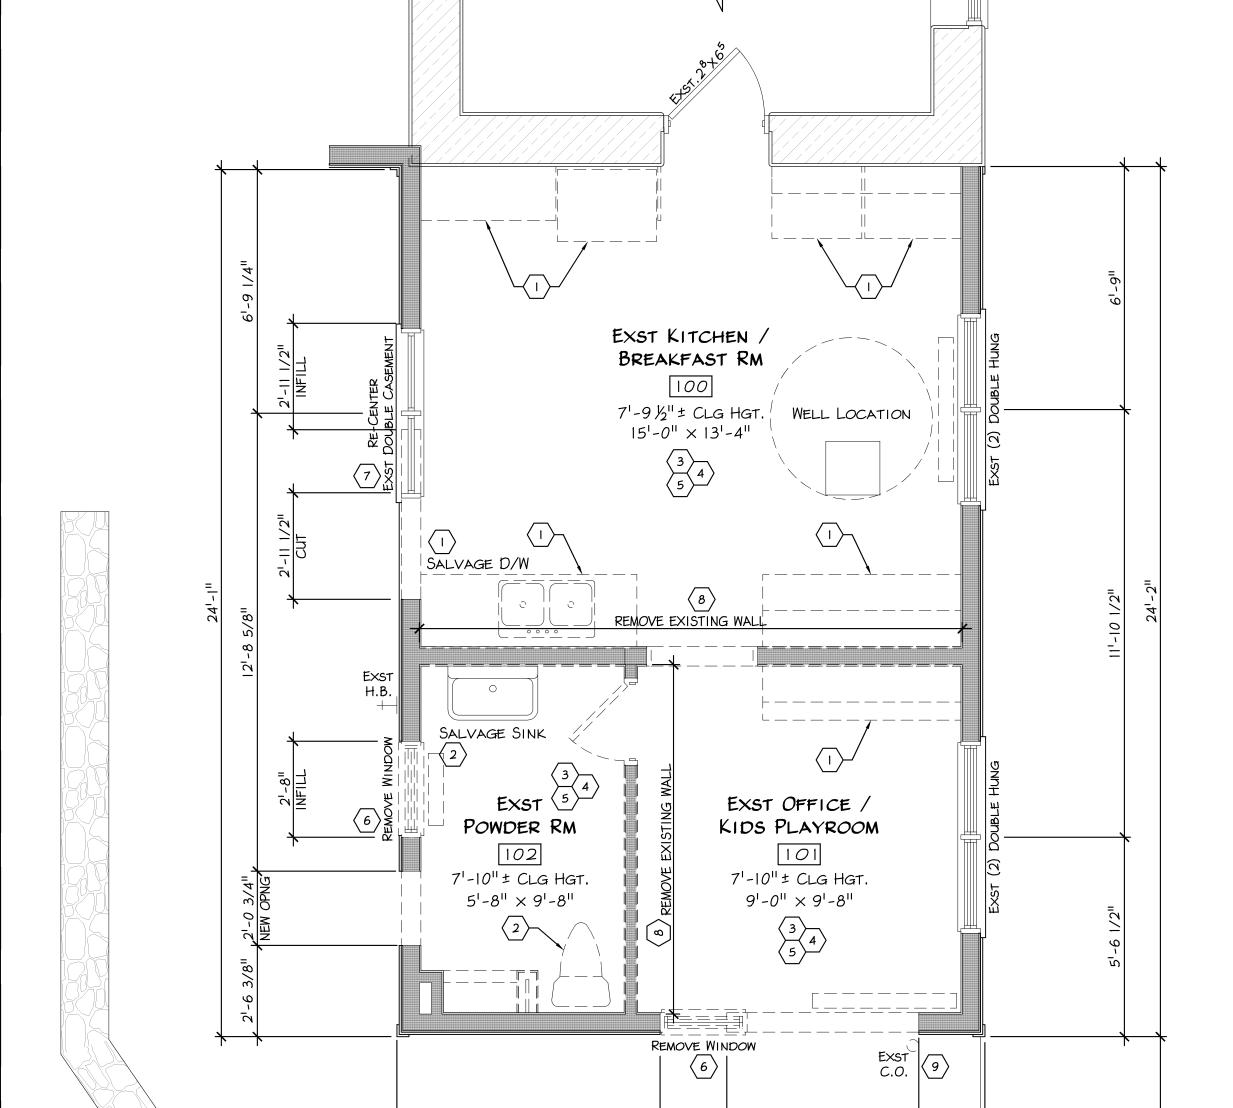




9'-2"

NEW OPENING

16¹-4"

EXST OUTDOOR PATIO

 $103 \\ 16^{1} - 0^{11} \times 12^{1} - 0^{11}$

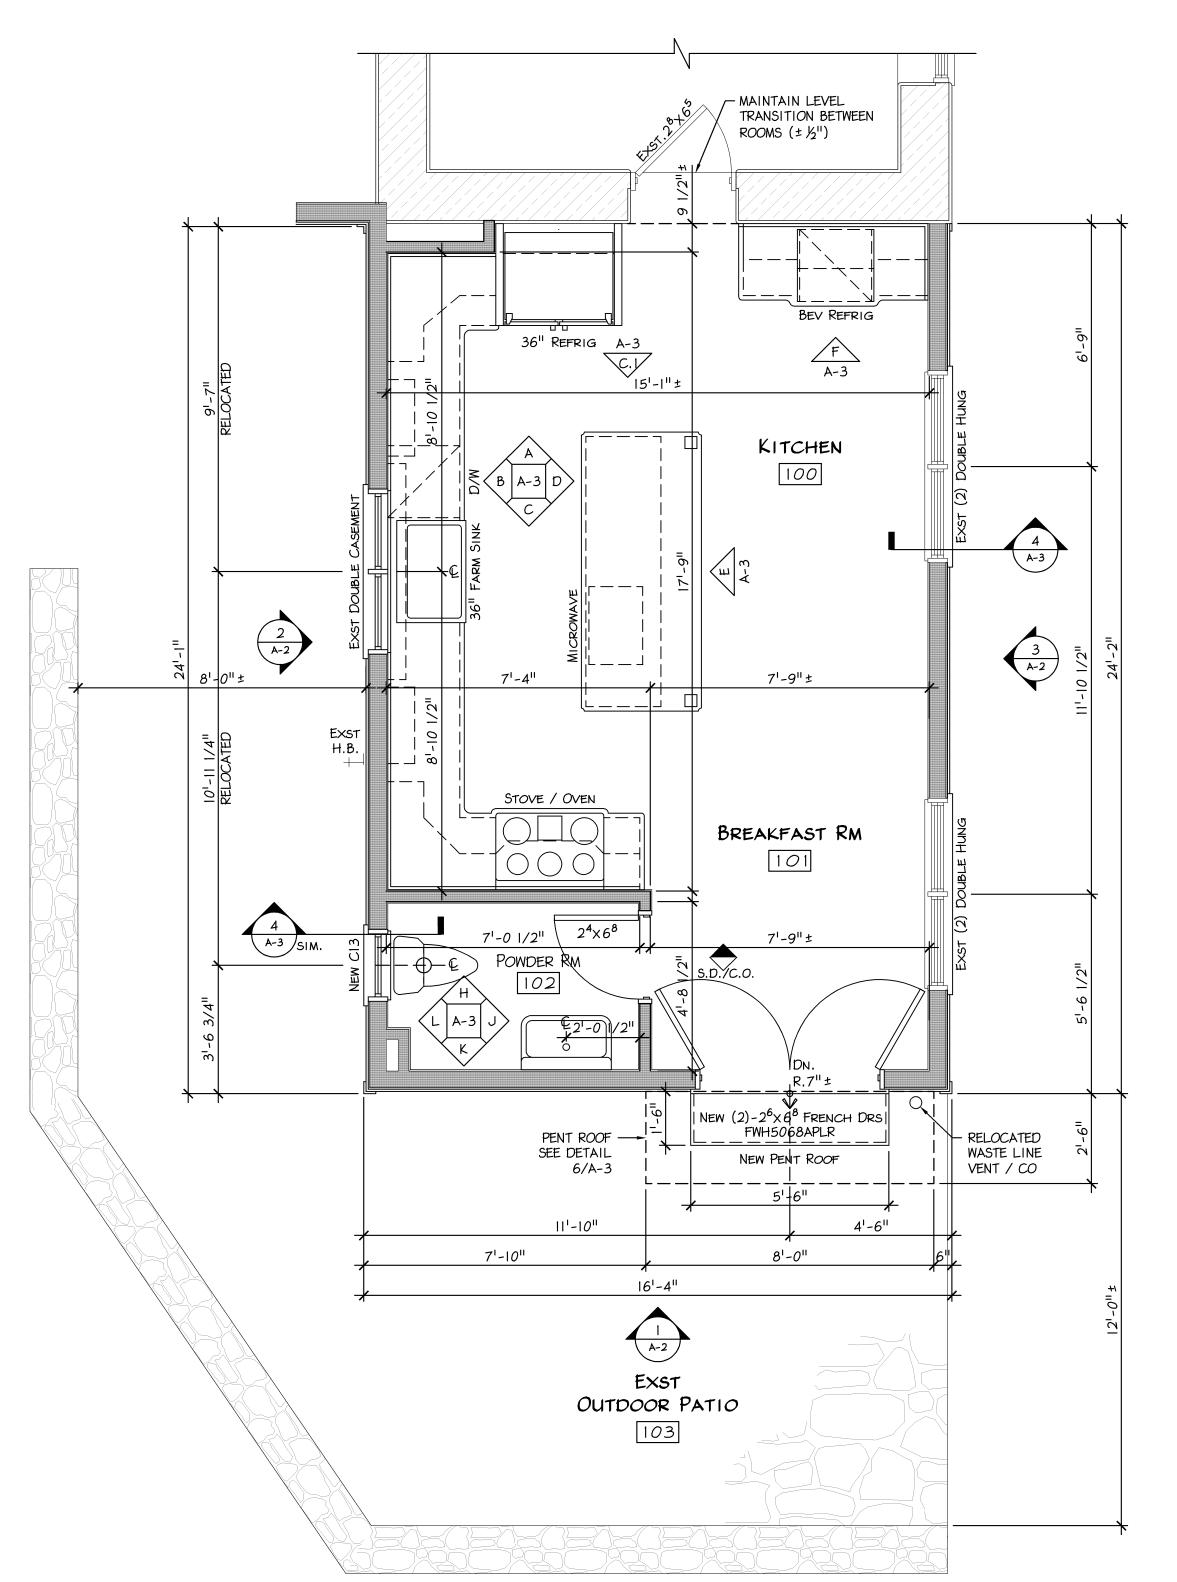

DEMOLITION GENERAL NOTES

GENERAL NOTES

UNLESS NOTED OTHERWISE.
ALL NEW EXTERIOR WALLS SHALL BE 2×6 STUDS

AT 16" O.C. MAX. UNLESS NOTED OTHERWISE.

ALL NEW INTERIOR WALLS SHALL BE 2×4 STUDS

AT 16" O.C. MAX. UNLESS NOTED OTHERWISE.

WHERE DRAWINGS ARE IN CONFLICT WITH OTHER DRAWINGS, CONTRACTOR SHALL NOTIFY THE ARCHITECT.

UNDER ALL PARTITIONS WHICH ARE PARALLEL


ALL LUMBER IN CONTACT WITH MASONRY OR

CONCRETE SHALL BE PRESSURE TREATED.

ALL SILLS AND PLATES SHALL BE SEALED. DOUBLE FLOOR JOIST SHALL BE INSTALLED

ALL DIMENSIONS ARE TO ROUGH FRAMING

- INSTALL TEMPORARY SUPPORT WALLS PRIOR TO THE REMOVAL OF BEARING WALLS.
- COORDINATE AND VERIFY THE NEW ROUGH OPENINGS WITH THE WINDOW AND DOOR MANUFACTURER.
- GENERAL CONTRACTOR SHALL BRING ALL DISCREPANCIES TO THE IMMEDIATE ATTENTION OF THE

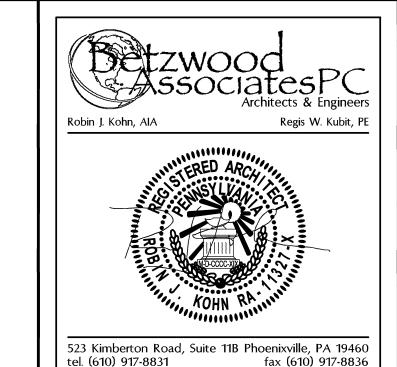

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Robin J. Kohn, AIA Commonwealth of Pennsylvania License No. RA-11327-X

> Contact Person: Edward (Kipp) Happ (610) 917-8831

B4036		EI	MH	RJK
NO.	DATE	⊣ BY	ISSUE	J L
1	02-12-2016		SKETCH PLAN	REVIEW
'	02-12-2010	EMIT		
2	02-19-2016	EMH	SKETCH PLAN	
	1		& PRELIM PRI	IT REVIEW DRAWINGS
3	02-26-2016	EMH	FIXELIM FLIXMI	IT KEVIEW DIVAMINGS
4	04-08-2016	ЕМН	ISSUED FOR F	PREMIT & CONSTRUCTIO
<u> </u>	04-00-2010	LMIT	REVISED PER	NEW CABINET LAYOUT
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APPF	ROVED BY		CURREN	NT DATE
Robii	n J. Kohn, AlA		April 0	8, 2016

Schmitt & Malavolta Residence

1030 Hershey Mill Road West Chester, PA 19380

East Goshen Township Chester County

KITCHEN FLOOR PLANS NOTES & SCHEDULE


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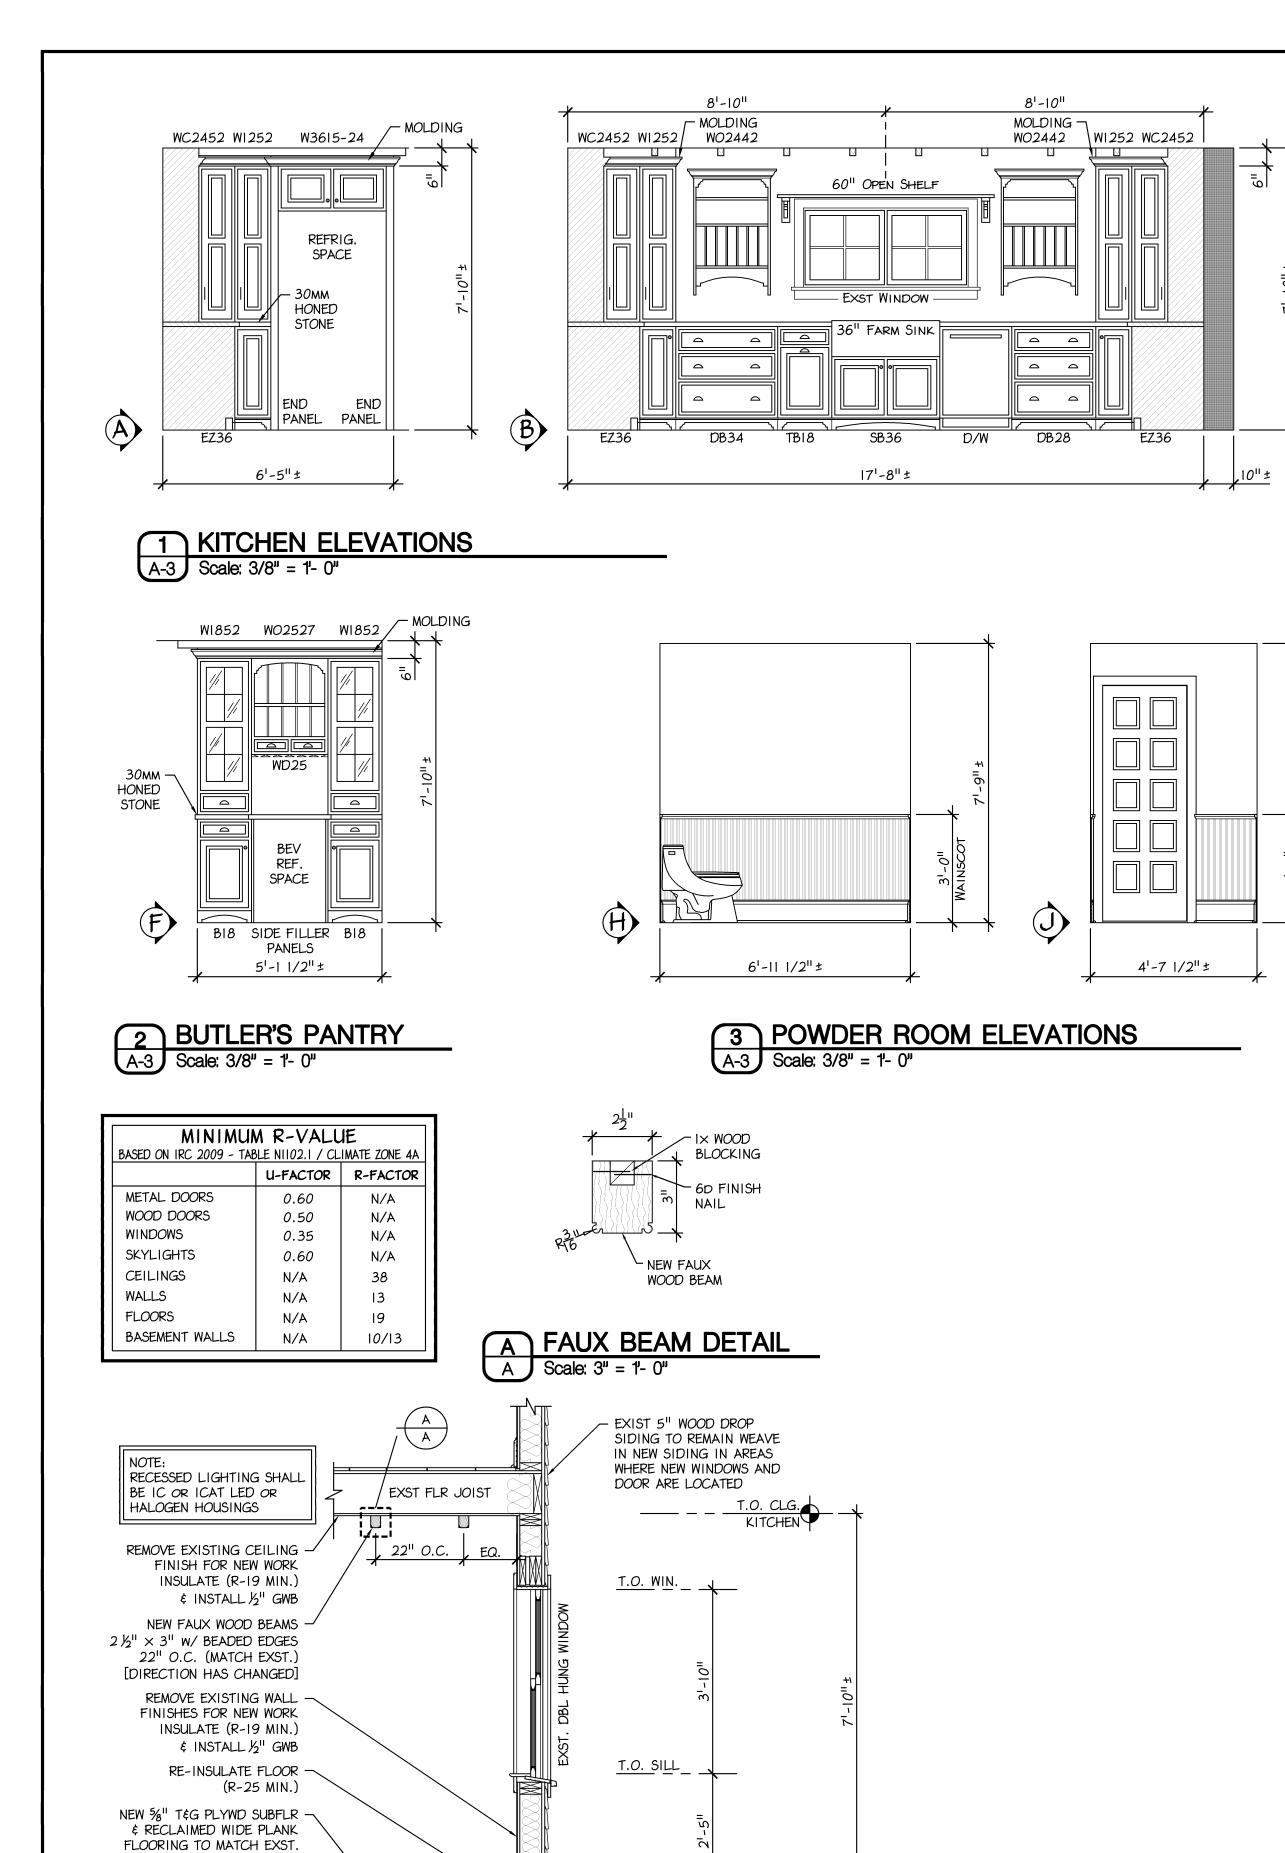
A-1

REV 4

NEW KITCHEN FLOOR PLAN

A-1 Scale: 3/8" = 1- 0"



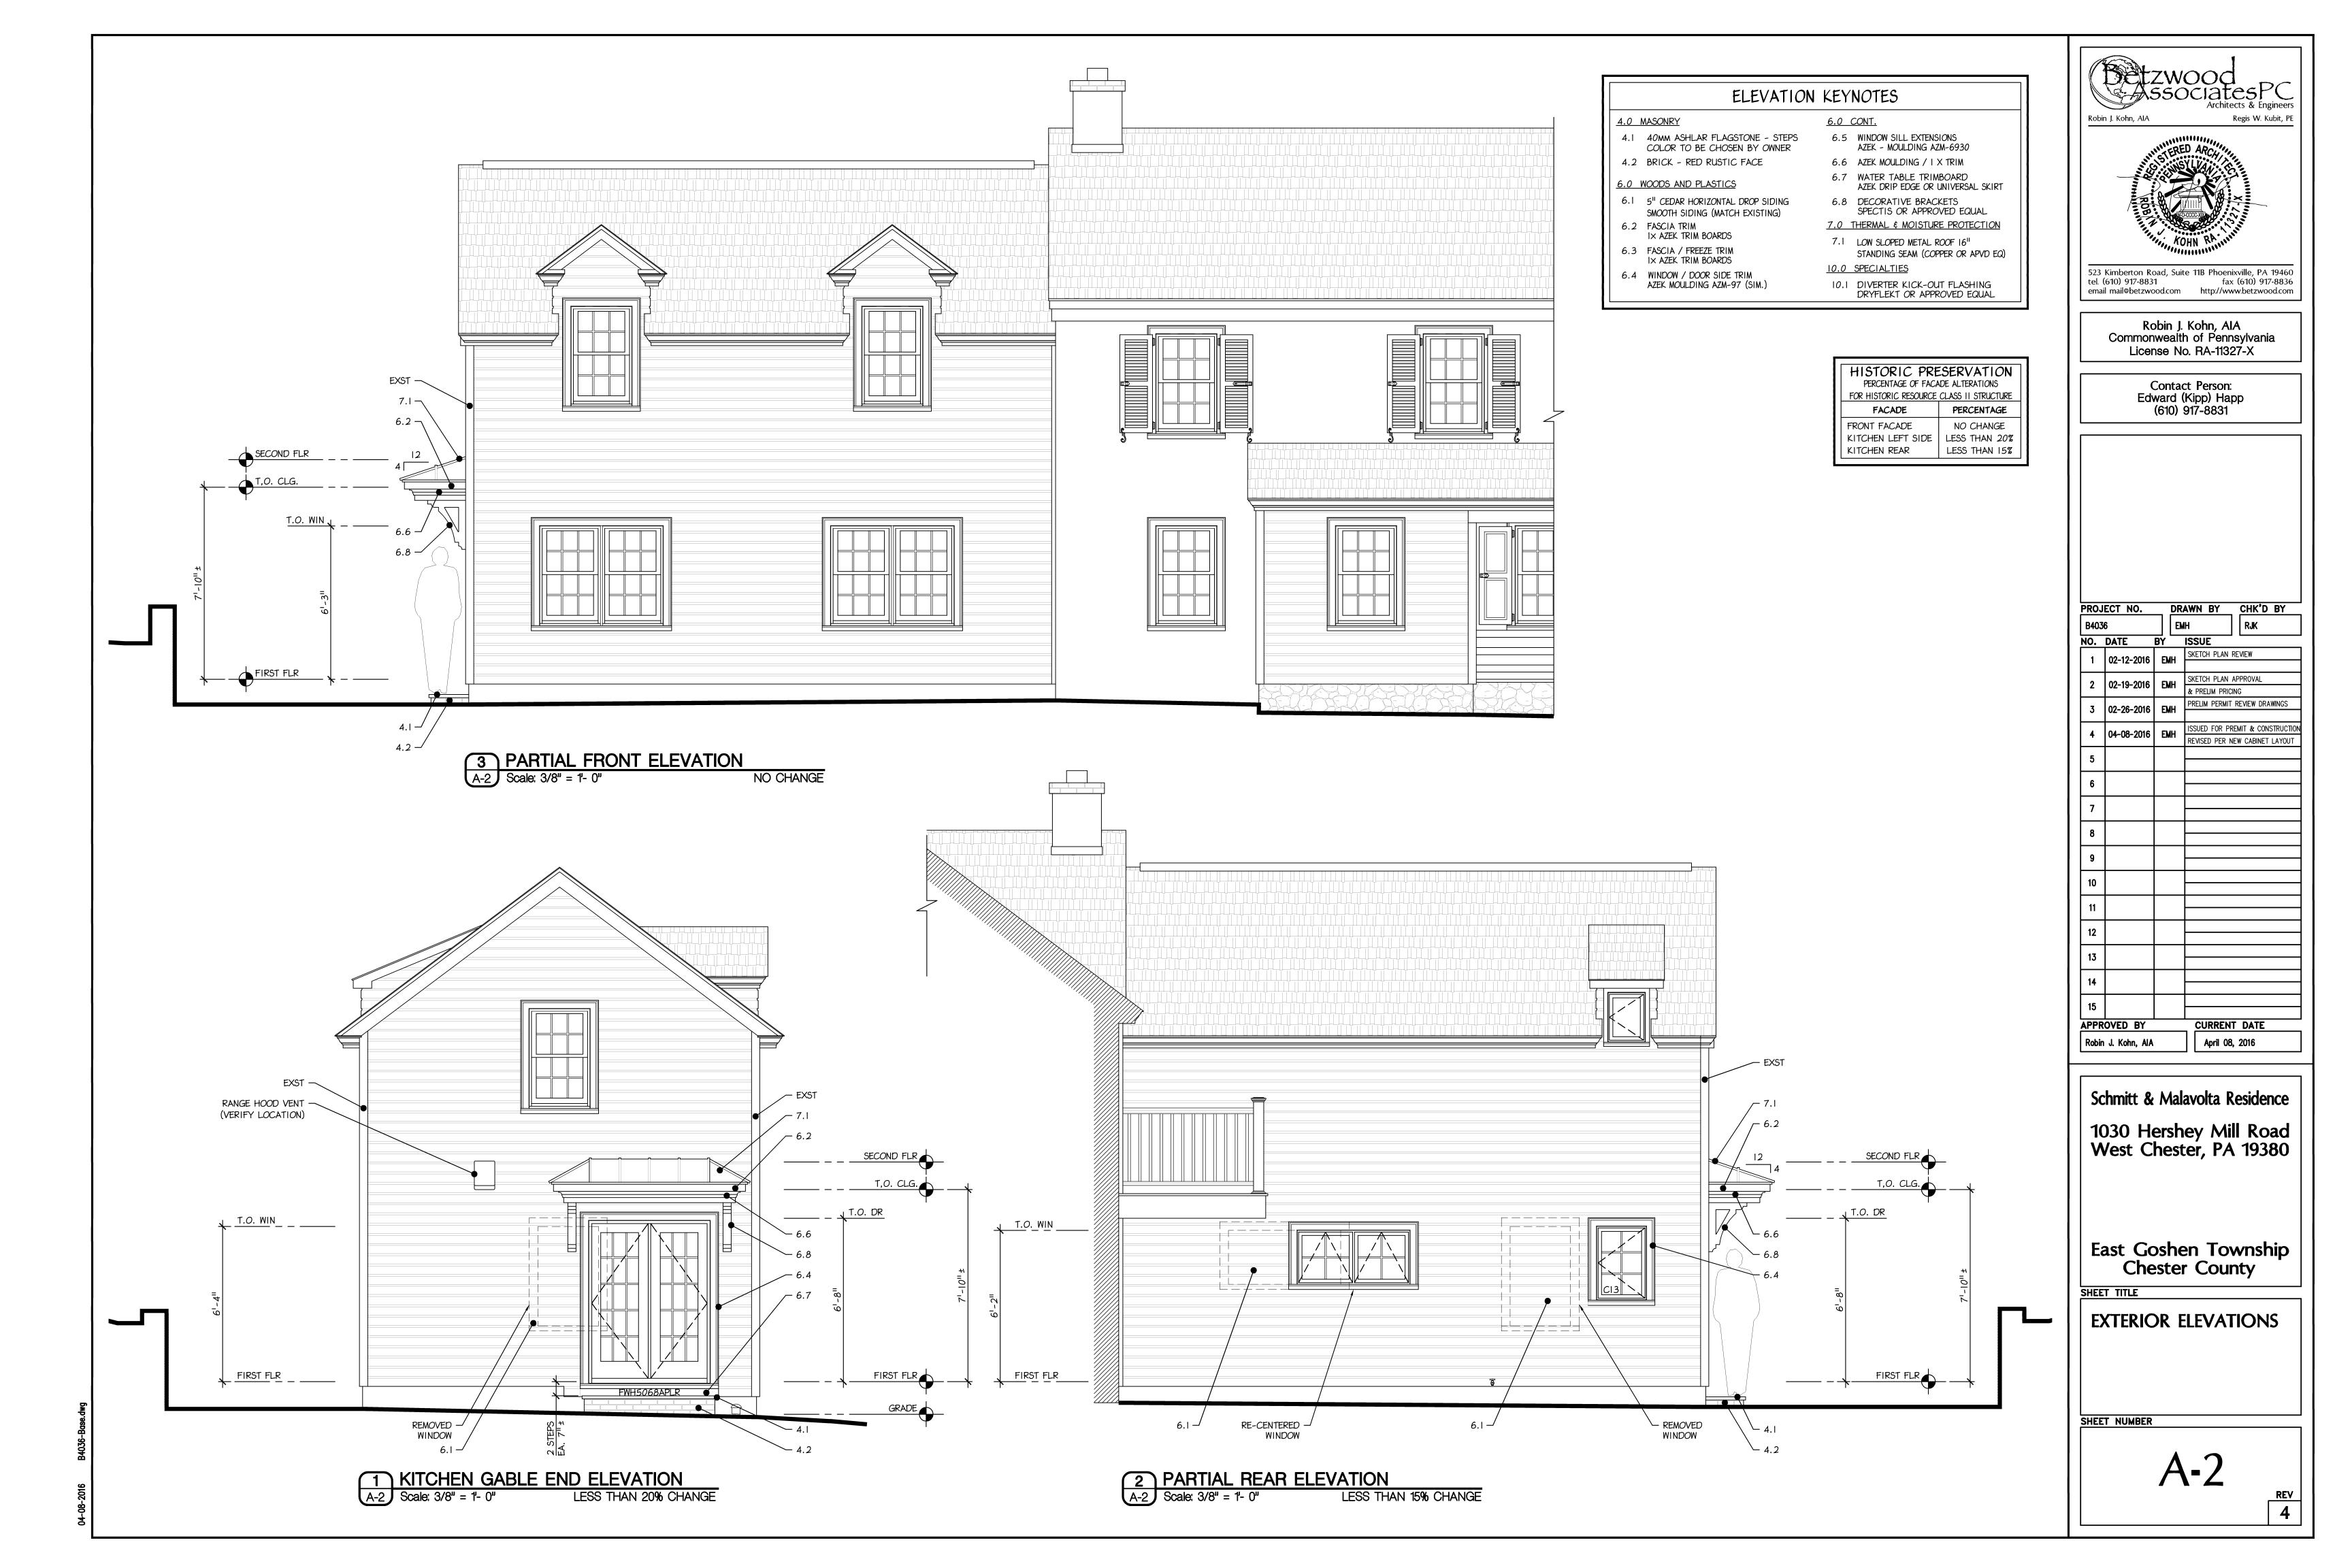

FIRST FLOOR
KITCHEN

- EXIST RUBBLE FND WALL

VERIFY WALL IS SOUND

PRIOR TO SOIL REMOVAL

(NOTIFY ARCHITECT PRIOR TO EXCAVATION OF SOILS)

EXISTING FLOOR JOIST

(NOTIFY ARCHITECT PRIOR

TO PERFORMING REPAIR)

REMOVE EXCESSIVE SOILS -

POLY (VAPOR BARRIER)

A-3 Scale: 1/2" = 1'- 0"

(4) KITCHEN BUILDING SECTION

FROM UNDER FLOOR JOIST

NEW 2-3" CONCRETE "RAT" -SLAB ON 3" 2B CLEAN STONE OR BAR SAND AND 6-MIL

REPAIR ANY DAMAGE

EXST, FLR JOIST

MOLDING -

30MM HONED -

STONE

WI252 WC2452

50MM HONED -

NEW WINDOWS

/TOILET

4'-7 1/2"±

HONED

STONE

MICROWAVE

7'-6"±

36" H00D

WALL OVEN


OVAL MIRROR

EXST SINK

6'-11 1/2"±

7'-0"±

□ | ELEC COOKTOP |

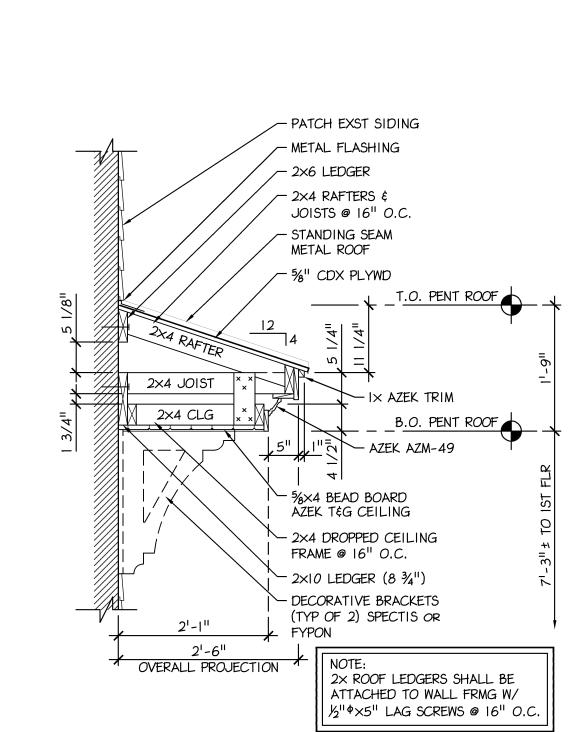


50mm -HONED


STONE

PANELS

7'-6"±


SECTION B-B

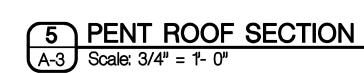

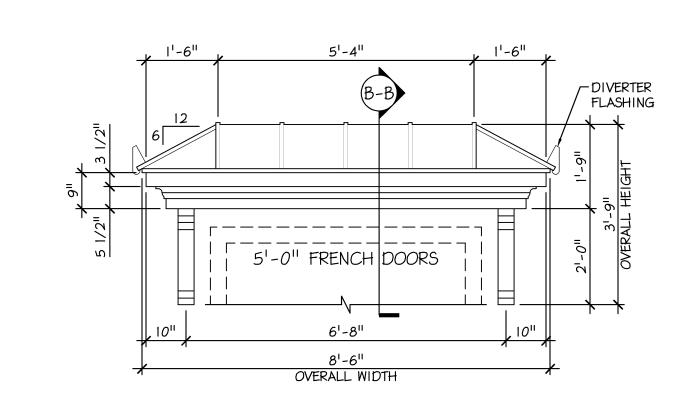

6 PENT ROOF ELEV. AT FRENCH DOORS

A-3 Scale: 1/2" = 1'- 0"

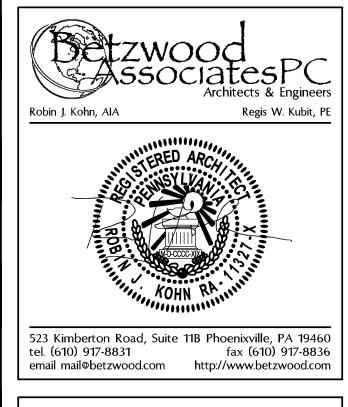

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NO. 1 2 3	DATE 02-12-2016	BY	ISSUE	
2				
		EMH	SKETCH PLAN	REVIEW
3	02-19-2016	EMH	SKETCH PLAN	
	02-26-2016	EMH	+	REVIEW DRAWINGS
4	04-08-2016	EMH		REMIT & CONSTRUCTI
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East Goshen Township Chester County


<u>|</u> Sheet title


INTERIOR ELEVATIONS, BUILDING SECTIONS & DETAILS

SHEET NUMBER

A-3

REV 4

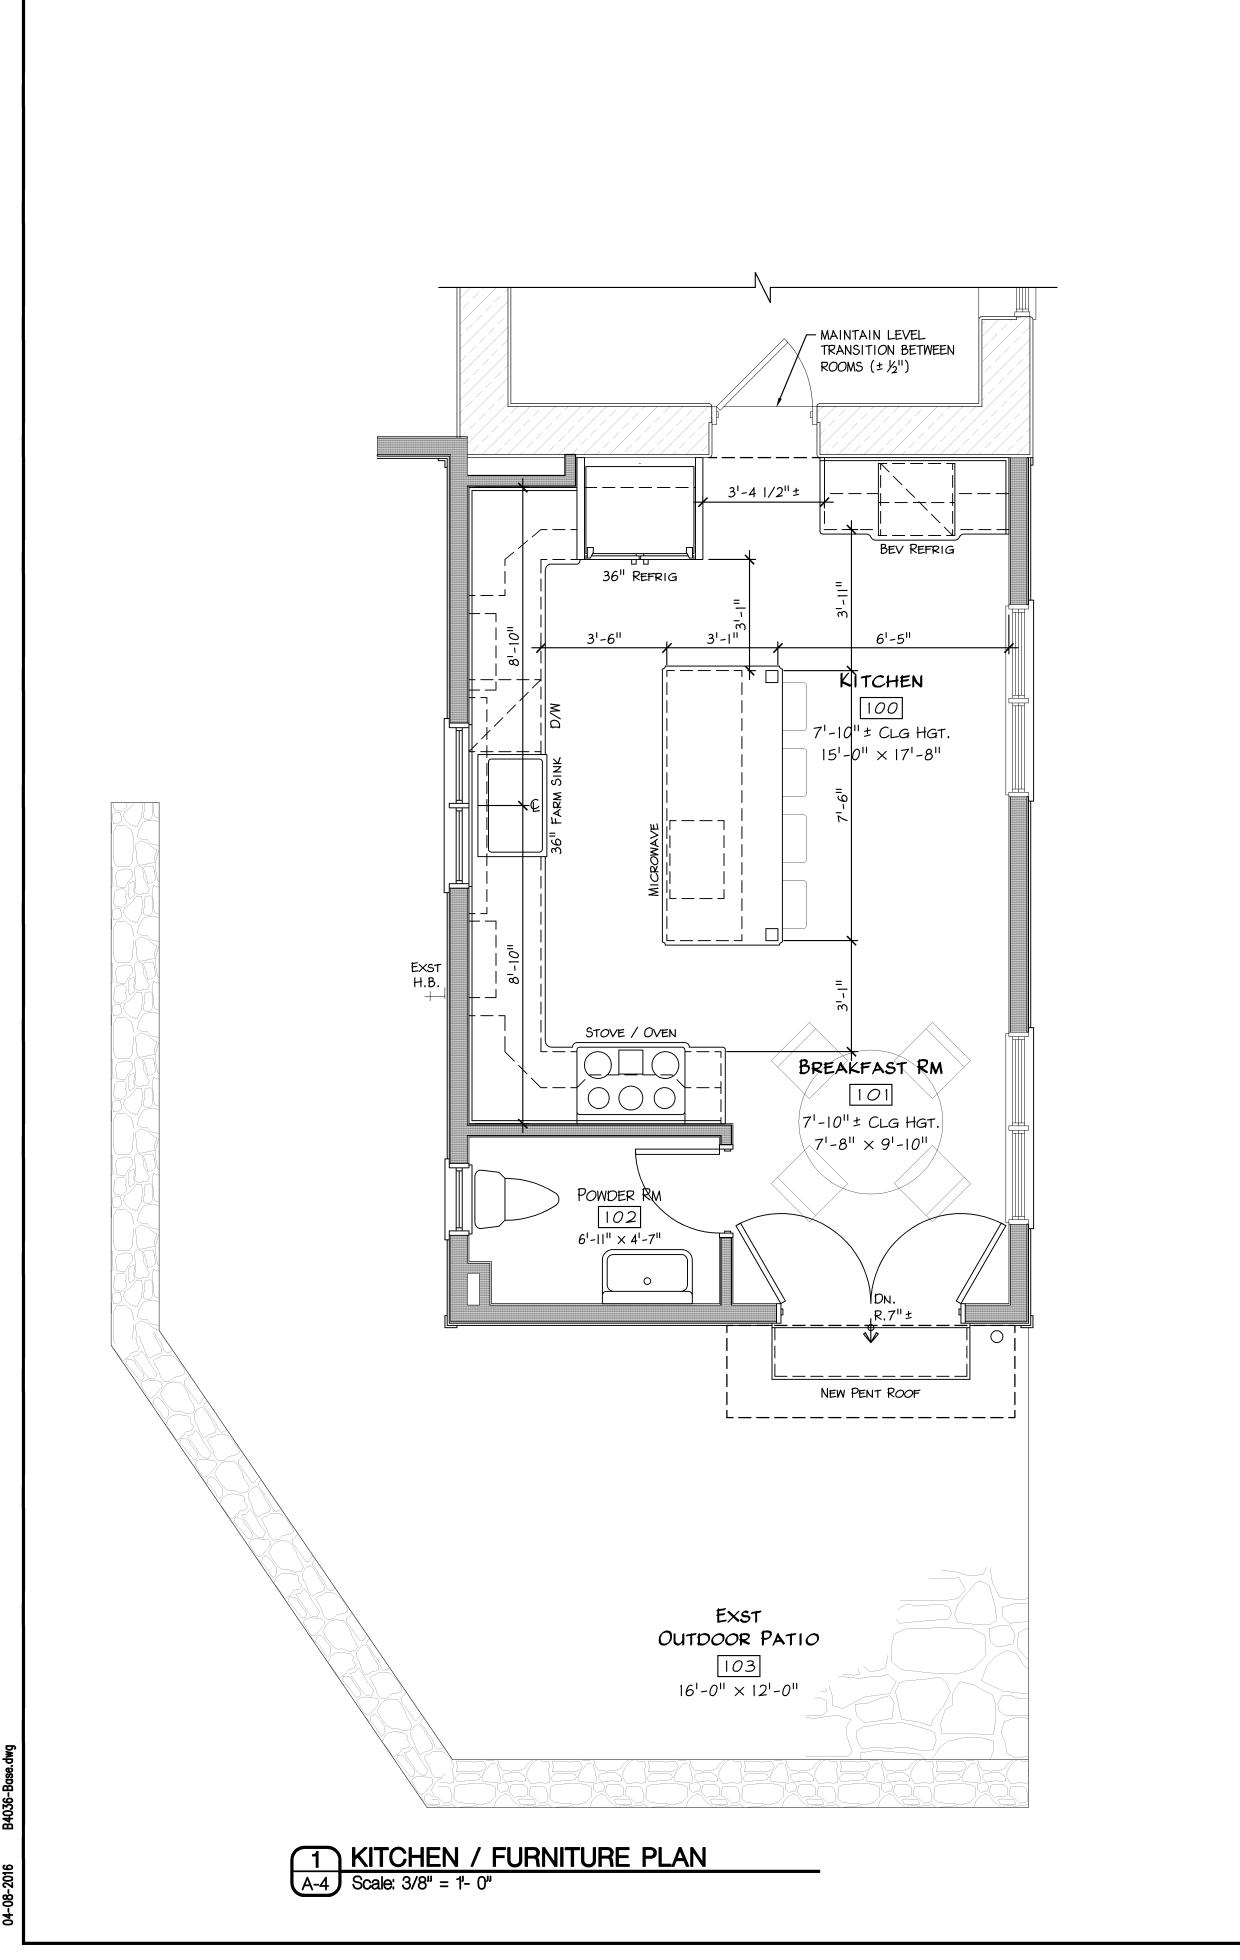

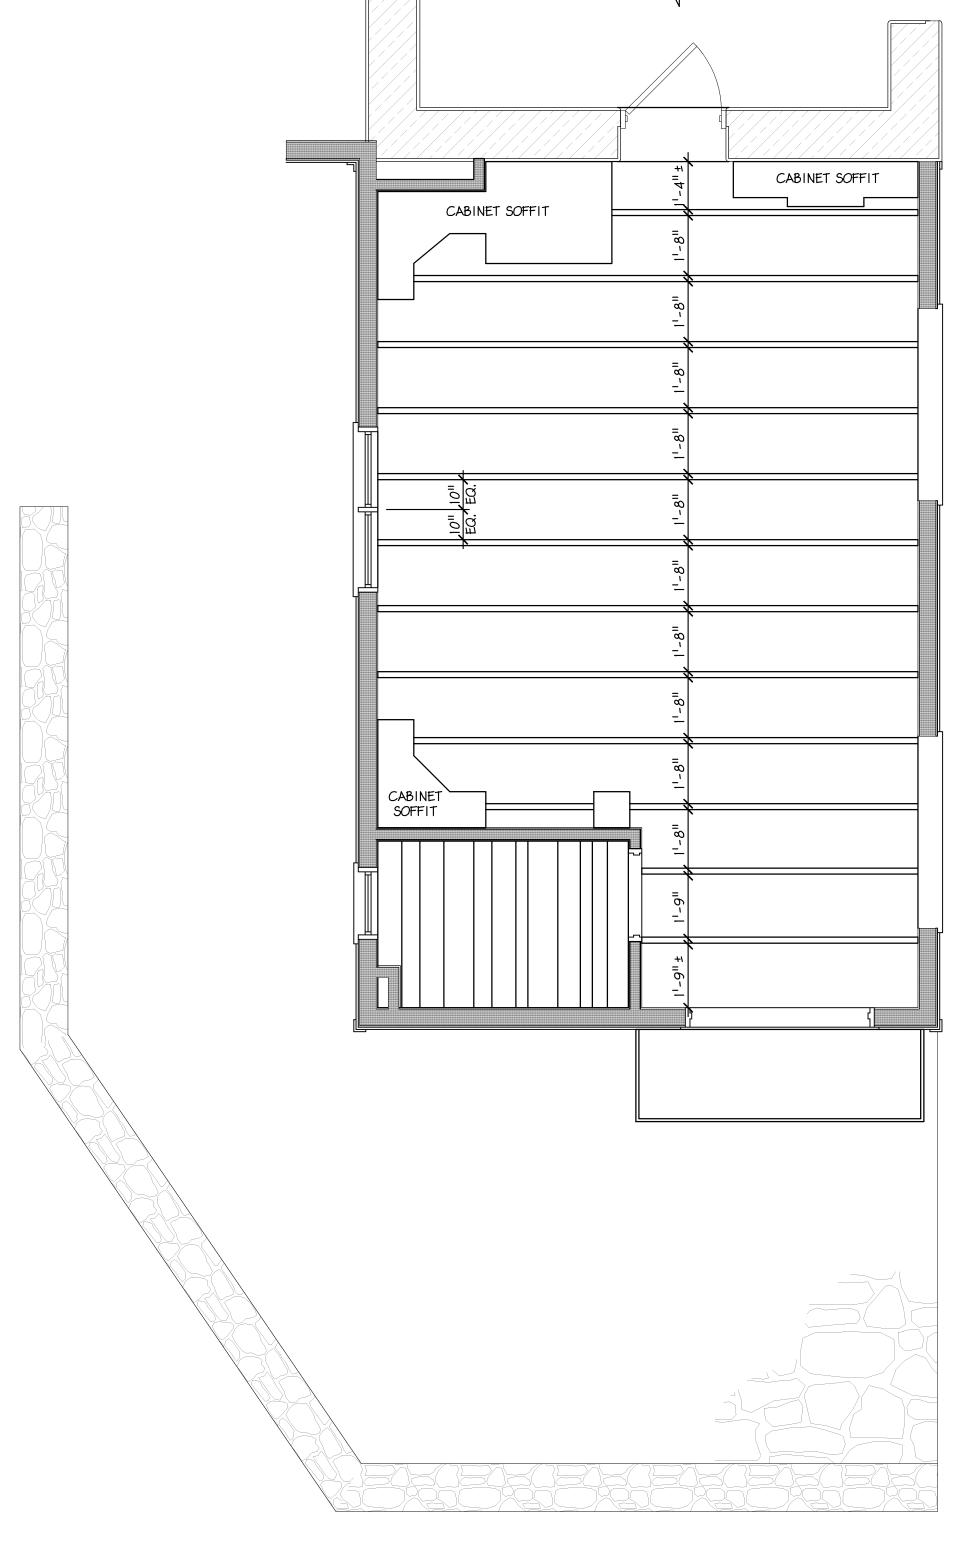

Robin J. Kohn, AIA

Regis W. Kubit, PE



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| ROJECT NO. | DRAWN BY | CHK'D BY | EMH | RJK |

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1030 Hershey Mill Road West Chester, PA 19380

East Goshen Township Chester County

SHEET TI

KITCHEN FURNITURE & REFLECTED CEILING PLAN


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A-2


REV 4

2 KITCHEN REFLECTED CEILING PLAN


A-4 Scale: 3/8" = 1- 0"

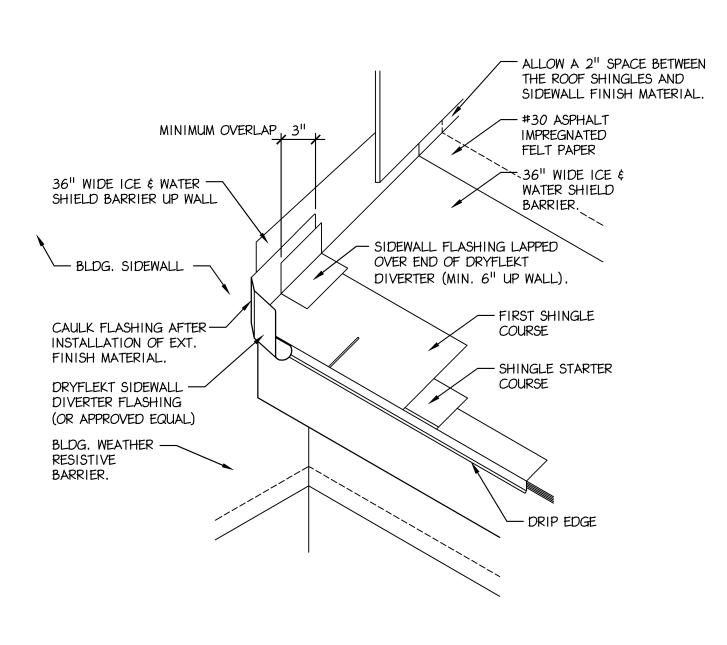

1 TYP. DIVERTER FLASHING A-5 Scale: 3/4" = 1-0"

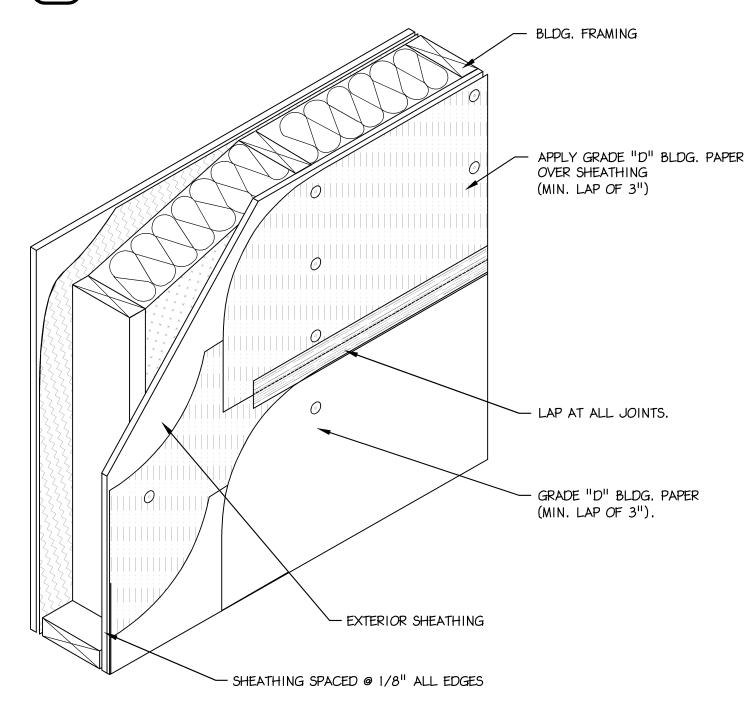


2 TYP. WEATHER BARRIER WRAP A-5 Scale: 3/4" = 1-0"

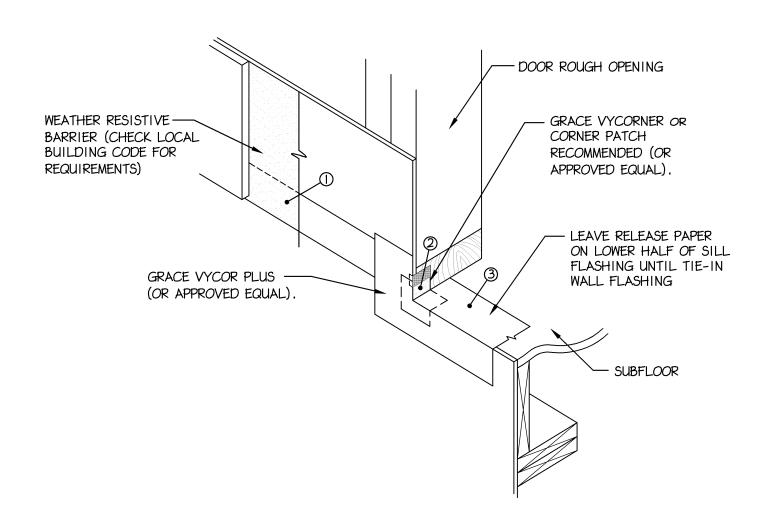


3 TYP. DOOR SILL FLASHING DETAIL

A-5 Scale: 3/4" = 1'- 0"

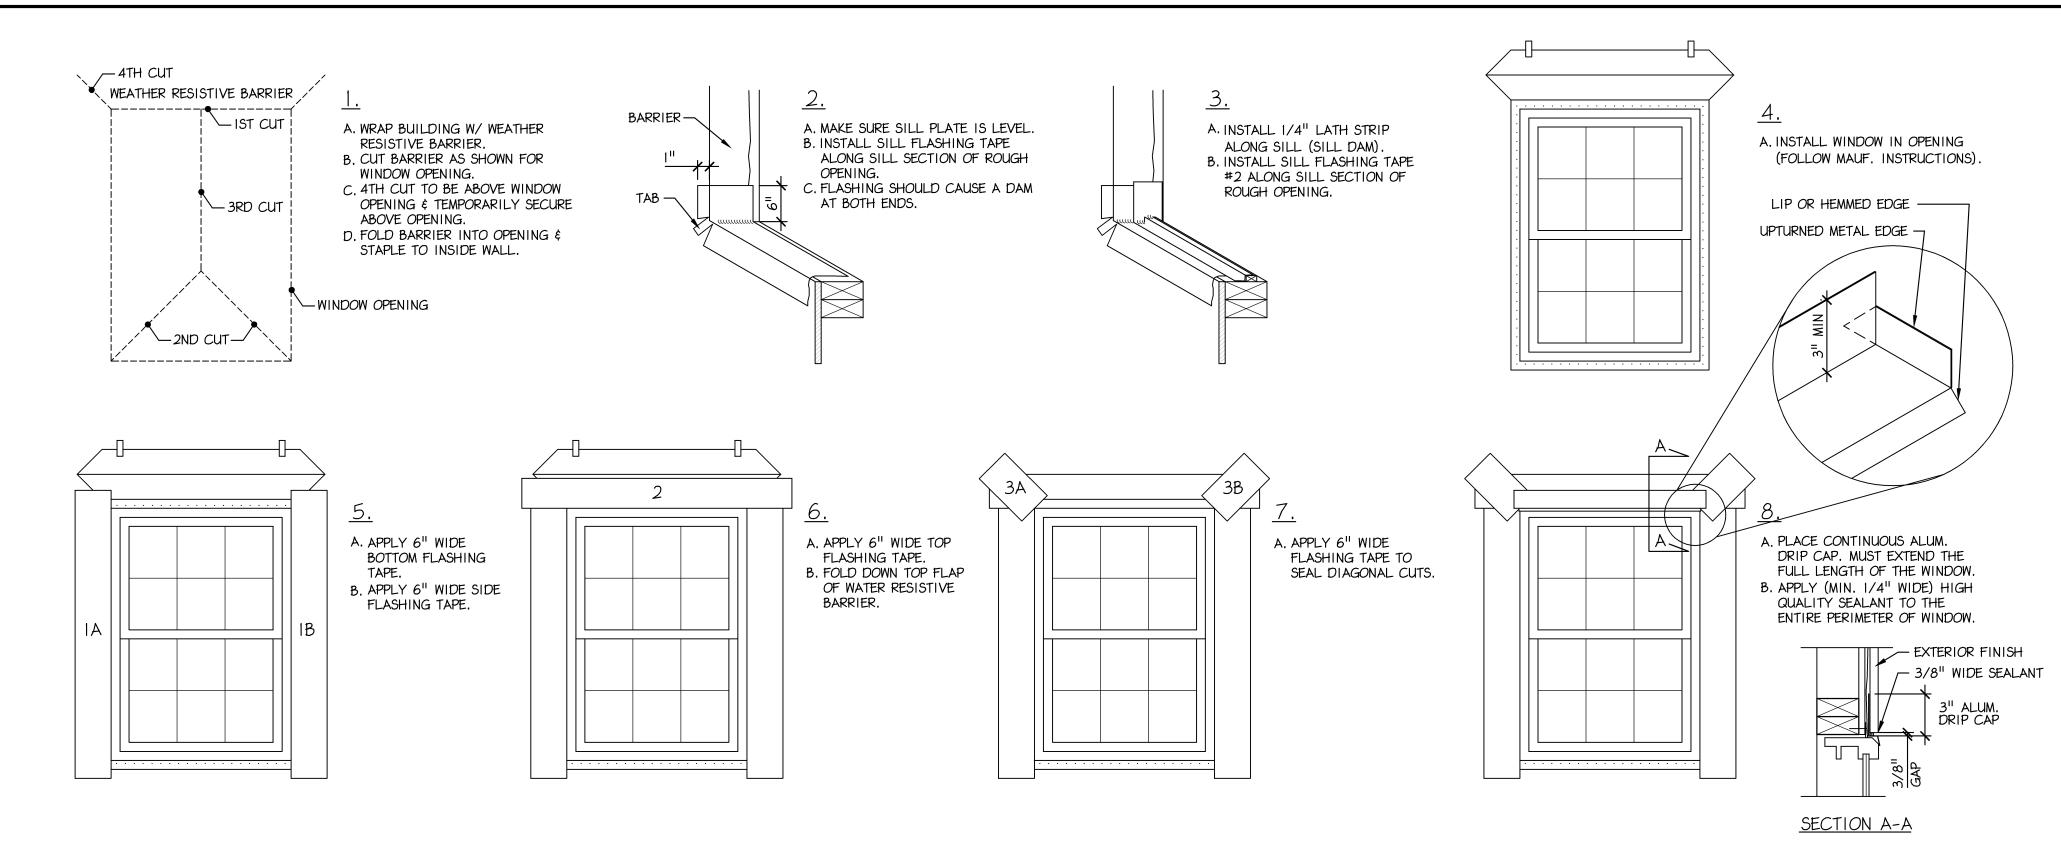

4 TYP. WINDOW FLASHING & SEALING

- WOOD SIDING CODE APPROVED WEATHER RESISTIVE BARRIER DUPONT TYVEK STUCCO WRAP OVERLAYED W/ GRADE "D" BUILDING PAPER. MOLDING ₹~3/8" MIN. TYP. - BACKER ROD AND SEALANT - CONT. DRIP CAP WOOD WINDOW

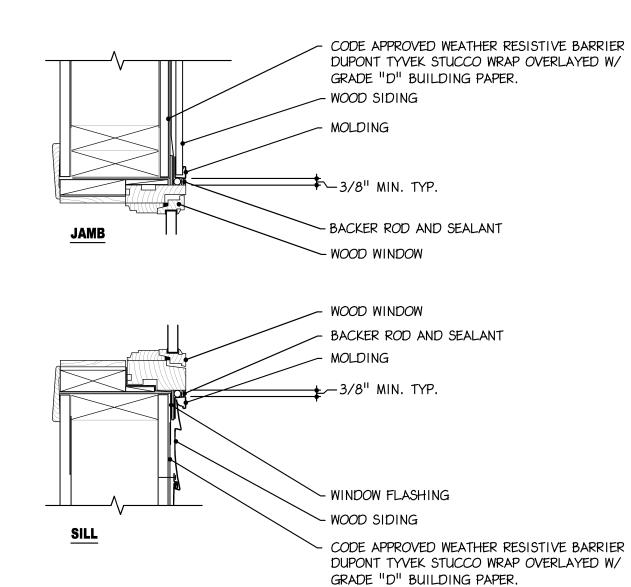

5 TYP. SIDING DETAIL AT WINDOW

A-5 Scale: 3/4" = 1'- 0"

SEALANT NOTES:

- · THE ALTERNATIVE AIRTIGHT DRYWALL APPROACH (ADA) TO BUILDING. RATHER THAN SPRAY FOAM OR POLYETHYLENE SHEETING, THE DRYWALL IN ITSELF IS A SUITABLE AIR BARRIER. THIS DETAIL SHOWS A WALL BUILT WITH THE AIRTIGHT-DRYWALL TECHNIQUE, CAULK, GASKETS, AND SEALED ELECTRICAL BOXES AND PENETRATIONS ARE ALL NECESSARY FOR SUCCESS WITH THIS BUILDING APPROACH.
- 2. SEAL ALL DRYWALL PENETRATIONS WITH AN APPROPRIATE GASKET OR SEALANT

- CONTINUOUS BEAD OF ----SEALANT AT TOP PLATE - CONTINUOUS BEAD OF SEALANT AT — CONTINUOUS BEAD OF SEALANT DOOR HEAD AT WINDOW AND JAMBS PERIMETER -GASKETED OR WIDE FLANGED & AIR TIGHT ELECTRICAL BOX (SEAL FLANGE) -CONTINUOUS BEAD OF SEALANT AT BOTTOM

Air Barrier Sealant - Elevation

6 AIR BARRIER - ELEVATION
A-5 Scale: N.T.S.

Detzwood SsociatesPC Architects & Engineers
Robin J. Kohn, AIA Regis W. Kubit, PE
RED ARCHISYLVA ROHN RA
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Robin J. Kohn, AIA

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CHK'D BY DRAWN BY NO. DATE BY ISSUE SKETCH PLAN REVIEW 1 | 02-12-2016 | EMH SKETCH PLAN APPROVAL 2 | 02-19-2016 | EMH & PRELIM PRICING PRELIM PERMIT REVIEW DRAWINGS 3 | 02-26-2016 | EMH ISSUED FOR PREMIT & CONSTRUCTION 4 | 04-08-2016 | EMH REVISED PER NEW CABINET LAYOUT APPROVED BY CURRENT DATE Robin J. Kohn, AIA April 08, 2016

Schmitt & Malavolta Residence


1030 Hershey Mill Road West Chester, PA 19380

East Goshen Township **Chester County**


STANDARD DETAILS

SHEET NUMBER

A-5

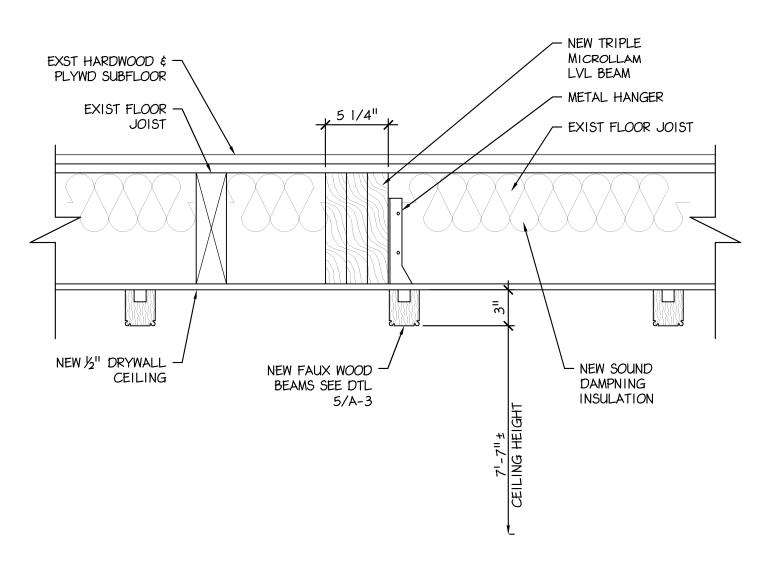

NEW SUPPORT BEAM DETAIL

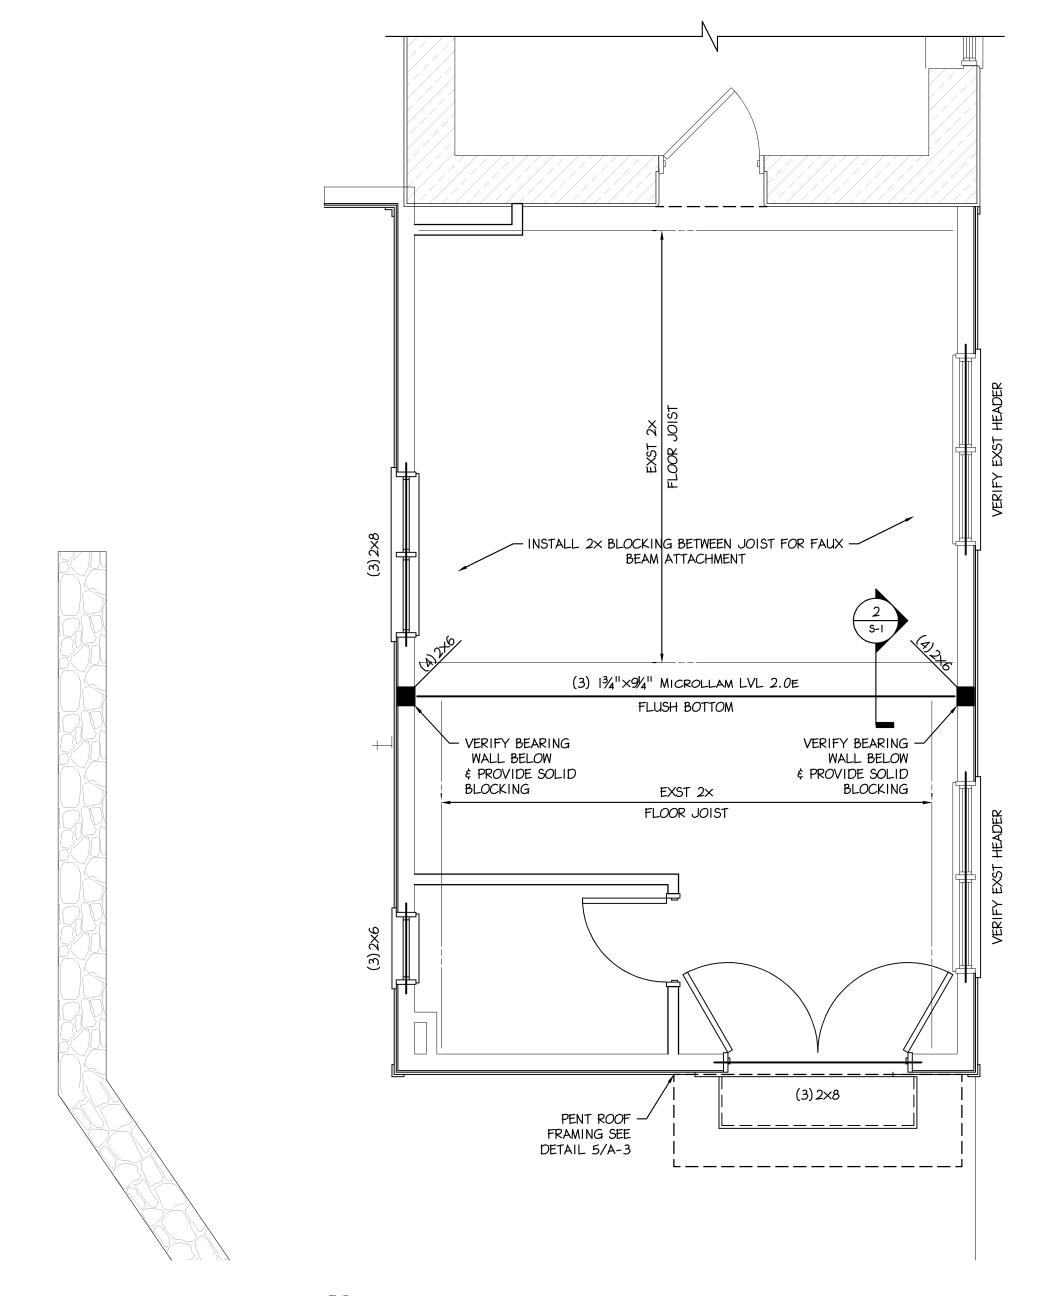



NOTES:

- DENOTES LOAD BEARING WALL
 DOUBLE FLOOR JOIST SHALL BE INSTALLED UNDER ALL
- PARTITIONS WHICH ARE PARALLEL TO JOISTS.

 3. ALL JOIST SHALL HAVE SOLID BRIDGING AT 6'-0' O.C. (MAX.). JOISTS SPANNING LESS THAN 12'-0" SHALL BE

BRIDGED AT MIDSPAN.

TIMBER NOTES

- ALL WOOD FRAMING SHALL BE FABRICATED, ERECTED, AND BRACED IN ACCORDANCE WITH THE NATIONAL DESIGN SPECIFICATION FOR WOOD CONSTRUCTION, LATEST EDITION
 ALL SAWN LUMBER SHALL BE HEM-FIR #2, 19% MAXIMUM MOISTURE CONTENT OR BETTER.
- THE MINIMUM DESIGN VALUES SHALL BE:

 FB = 850 PSI
- FV = 150 PSI
- FC = 1300 PSI
- E = 1,300,000 PSI
- MINIMUM DESIGN VALUES FOR PARALLAM (PSL) MEMBERS SHALL BE:
- FB = 2900 PSI FV = 290 PSI
- FC = 2900 PSI
- MINIMUM DESIGN VALUES FOR MICROLLAM (LVL) MEMBERS SHALL BE:
- E = 2,000,000 PSI
- FB = 2600 PSI FV = 285 PSI

FC = 2510 PSI

- E = 1,900,000 PSI

 3. ALL TIMBER CONNECTIONS SHALL BE MADE USING PREFABRICATED CONNECTORS.
 TOE-NAILING IS NOT PERMITTED. ALL STEEL TIMBER FASTENINGS AND JOIST HANGERS
 SHALL BE A MINIMUM OF 16 GA. GALVANIZED STEEL WITH A RATED LOAD CAPACITY
 EQUAL TO OR EXCEEDING THE IMPOSED LOADING REQUIREMENTS. SUBMIT MANUFACTURERS
 DATA FOR REVIEW. FASTENERS SHALL BE AS MANUFACTURED BY HECKMANN, KANT SAG,
- SIMPSON OR APPROVED EQUAL.

 4. ALL WOOD PLATES BEARING ON MASONRY OR CONCRETE WALLS SHALL BE PRESSURE TREATED LUMBER UNLESS NOTED OTHERWISE.
- 5. DOUBLE FLOOR JOIST SHALL BE INSTALLED UNDER ALL PARTITIONS WHICH ARE PARALLEL TO JOISTS.
- 6. ALL JOIST SHALL HAVE SOLID BRIDGING AT 6'-0' O.C. (MAX.). JOISTS SPANNING LESS THAN 12'-0" SHALL BE BRIDGED AT MIDSPAN.
- 7. ALL DOUBLE JOISTS SHALL BE SPIKED TOGETHER WITH 10D NAILS @ 16" O.C. ALL DOUBLE TJI JOISTS SHALL BE ATTACHED AS PER MANUFACTURERS RECOMMENDATIONS.
- 8. ALL WOOD BEAMS MADE UP OF 3 OR MORE MEMBERS SHALL BE BOLTED TOGETHER WITH %"\$ BOLTS @ 32" O.C.
 9. AT ROOF RAFTER SPACING GREATER THAT 19.2" O.C. INSTALL PLY CLIPS AT CENTERLINE
- 9. AT ROOF RAFTER SPACING GREATER THAT 19.2" O.C. INSTALL PLY CLIPS AT CENTERL OF PLYWOOD SPAN AND AT ALL EDGES PARALLEL TO SPAN.

10. PLYWOOD SHEATHING SHALL BE CONTINUOUS OVER A MINIMUM OF 3 SPANS.


AMERICAN INSTITUTE OF TIMBER CONSTRUCTION, LATEST EDITION

- PLYWOOD SHALL BE SECURED USING 8D NAILS.
 ALL PLYWOOD SHALL MEET THE REQUIREMENTS OF THE PLYWOOD DESIGN SPECIFICATIONS
 AS PUBLISHED BY THE AMERICAN PLYWOOD ASSOCIATION AND THE REQUIREMENTS OF THE
- 13. WOOD TRUSS JOISTS ARE TO BE DESIGNED BY THE MANUFACTURER, ALL CALCULATIONS SHALL BE SEALED BY A REGISTERED ENGINEER AND SHALL BE SUBMITTED FOR APPROVAL BY THE STRUCTURAL ENGINEER.


MISCELLANEOUS NOTES

- 1. THESE GENERAL NOTES SUPPLEMENT THE PROJECT SPECIFICATIONS. REFER TO PROJECT SPECIFICATIONS FOR ADDITIONAL REQUIREMENTS.
- 1.1. DISCREPANCIES FOUND IN THESE DRAWINGS AND SPECIFICATIONS SHALL BE IMMEDIATELY REPORTED IN WRITING TO THE ENGINEER FOR CLARIFICATION.
- IMMEDIATELY REPORTED IN WRITING TO THE ENGINEER FOR CLARIFICATION.

 2. STRUCTURAL DRAWINGS ARE INTENDED TO BE USED WITH ARCHITECTURAL, MECHANICAL AND PLUMBING DRAWINGS. CONTRACTOR IS RESPONSIBLE FOR COORDINATING SUCH REQUIREMENTS INTO THEIR SHOP DRAWINGS AND WORK.
- 3. NO OPENINGS SHALL BE MADE IN ANY STRUCTURAL MEMBER WITHOUT THE WRITTEN APPROVAL OF THE ARCHITECT/ENGINEER OF RECORD.
- 4. NO CHANGE IN SIZE OR DIMENSION OF THE STRUCTURAL MEMBERS SHALL BE MADE WITHOUT WRITTEN APPROVAL OF THE ARCHITECT/ENGINEER OF RECORD.
- 5. OPENINGS 1'-4" OR LESS ON A SIDE ARE GENERALLY NOT SHOWN ON THE STRUCTURAL DRAWINGS. REFER TO ARCHITECTURAL AND MECHANICAL DRAWINGS FOR SUCH OPENINGS.
- 6. DO NOT SCALE THESE DRAWINGS, USE DIMENSIONS.
 7. THE CONTRACTOR SHALL INFORM THE ARCHITECT/ENGINEER OF RECORD IN WRITING OF ANY DEVIATION FROM THE CONTRACT DOCUMENTS. THE CONTRACTOR SHALL NOT BE RELIEVED OF THE RESPONSIBILITY OF SUCH DEVIATION BY THE ARCHITECT/ENGINEER OF RECORD REVIEW OF SHOP DRAWINGS, PROJECT DATA, ETC., UNLESS THE CONTRACTOR HAS SPECIFICALLY INFORMED THE ARCHITECT/ENGINEER OF RECORD OF SUCH DEVIATION AT THE SUBMISSION, AND THE ARCHITECT/ENGINEER OF RECORD HAS GIVEN WRITTEN APPROVAL TO THE SPECIFIC DEVIATION.

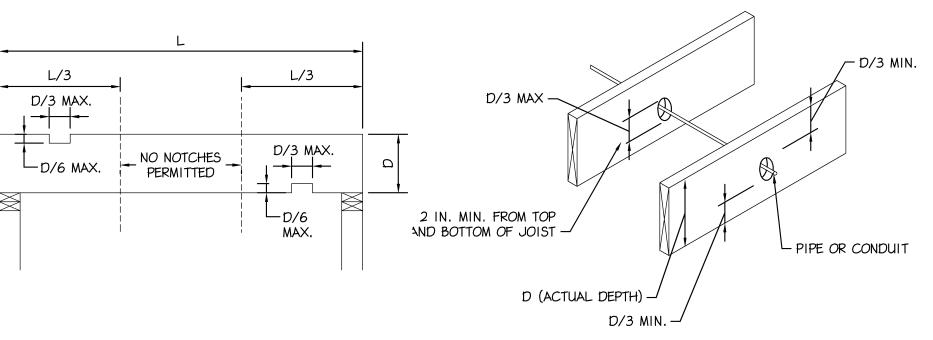

3 ALLOWABLE NOTCHING & DRILLING IN FRAMING S-1 Scale: 3/4" = 1'- 0"

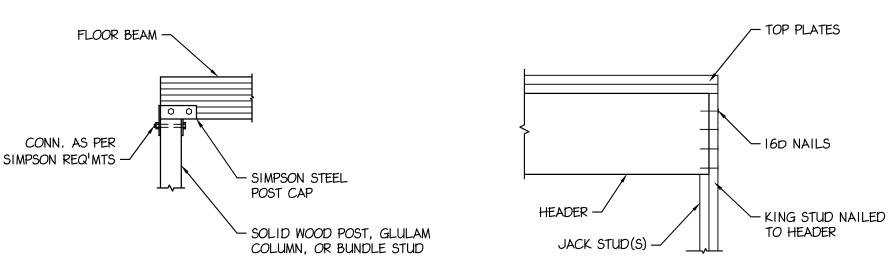

4 DTL BEARING END CONNECTION
S-1 Scale: 3/4" = 1-0"



LIVE LOADS

FLOOR LIVE LOADS
LIVE LOAD
STAIRWAY LIVE LOAD
MECHANICAL UNIT LOAD
APPLICABLE CODE: IRC 2009

40 PSF (LIVING AREAS)
100 PSF
SEE DRAWINGS

WIND LOAD

BASIC WIND SPEED - V (3-SEC. GUST): 90 MPH WIND LOAD IMPORTANCE FACTOR 1.0 WIND LOAD EXPOSURE CATEGORY B INTERNAL PRESSURE COEFFICIENT ± 0.25 WIND DESIGN PRESSURE 25 PSF

SEISMIC LOAD SEISMIC DESIGN CATEGORY: C

SEISMIC DESIGN CATEGORY:

SEISMIC USE GROUP:

SPECTRAL RESPONSE COEFFICIENT - SDS:

SPECTRAL RESPONSE COEFFICIENT - SDI:

SITE CLASS:

BASIC SEISMIC FORCE RESISTING SYSTEM:

C

0.339

0.133

SITE CLASS:

D

BASIC SEISMIC FORCE RESISTING SYSTEM:

LIGHT FRAME WALLS

ANALYSIS PROCEDURE: EQUIVALENT LATERAL FORCE PROCEDURE

WIND LOAD CONTROLS DESIGNS FOR LATERAL FORCES

FOUNDATION NOTES

- FOUNDATION SOIL BEARING PRESSURE 2,000 PSF
 FOUNDATION SHALL BE PLACED ON VIRGIN SOIL AT ELEVATIONS INDICATED ON
- DRAWINGS.
 3. THE ENGINEER SHALL APPROVE ALL BEARING STRATA PRIOR TO PLACEMENT OF THE
- CONCRETE FOOTINGS.

 4. INSTALL CRACK CONTROL OR CONSTRUCTION JOINTS AT 30-FOOT MAXIMUM CENTERS IN WALLS. LOCATIONS SHALL BE APPROVED BY ARCHITECT/ENGINEER.

W/ SHEAR PANELS

- 5. TOP OF FOOTING ELEVATIONS ARE NOTED (000.00')
- TOP OF PIER OR WALL ELEVATIONS ARE NOTED [000.00']

 6. ALL TOPSOIL, SOIL FILL, AND SOFT SUBSOIL SHALL BE REMOVED AND, IF NECESSARY, REPLACED WITH COMPACTED LOAD-BEARING FILL MATERIALS. TEST PITS OR SOIL BORINGS SHALL BE CONDUCTED TO DETERMINE THE LOCATION OF THE VIRGIN SOIL.
- 7. ANY UNDERCUT AND REPLACEMENT WITH COMPACTED LOAD-BEARING FILL SHALL EXTEND LATERALLY BEYOND FOOTINGS A DISTANCE AT LEAST EQUAL TO THE DEPTH OF THE UNDERCUT.
- 8. AFTER UNDERCUTTING AND REMOVAL OF UNSUITABLE SOIL, THE EXPOSED UNDERLYING RESIDUAL SOILS IN THE PROPOSED BUILDING AREA SHALL BE PROOFROLLED AND COMPACTED. SOFT AND/OR UNSTABLE AREAS DISCLOSED BY THE PROOFROLLING SHALL BE ROLLED UNTIL STABILITY IS OBTAINED OR UNTIL FURTHER UNDERCUT TO FIRM MATERIAL IS REACHED.
- 9. FOOTINGS SHALL BE BASED ON STIFF SUBSOIL OR LOAD-BEARING FILL MATERIALS WITH A MINIMUM DEPTH OF AT LEAST TWO FEET OR ONE-HALF THE FOOTING WIDTH, WHICHEVER IS GREATER, BELOW THE FOUNDATION BEARING LEVEL.
- 10. PLACE LOAD-BEARING FILL MATERIALS IN LAYERS NOT MORE THAN EIGHT INCHES IN LOOSE THICKNESS FOR MATERIAL COMPACTED BY HEAVY COMPACTION EQUIPMENT, AND NOT MORE THAN FOUR INCHES IN LOOSE DEPTH FOR MATERIAL COMPACTED BY HAND-OPERATED TAMPERS. FILL MATERIAL SHALL BE MOISTENED OR AERATED AS NECESSARY.
- 11. EACH LIFT SHALL BE COMPACTED TO AN AVERAGE DRY DENSITY OF NOT LESS THAN 98% OF THE MAXIMUM DRY DENSITY ACCORDING TO ASTM D698 (STANDARD PROCTOR) FOR ALL FOOTING AND FLOOR SUBGRADES.
- 12. THE SUB-FLOOR MATERIALS SHALL CONSIST OF AT LEAST FOUR TO SIX INCHES OF GRAVEL OR CRUSHED STONE. THE SUB-FLOOR MATERIALS SHALL BE COMPACTED BY AT LEAST FOUR COVERAGES OF A HEAVY-DUTY VIBRATORY ROLLER OR UNTIL NO FURTHER COMPACTION IS OBSERVED. SEE THE DRAWINGS AND SPECIFICATIONS FOR THE VAPOR BARRIER SIZE, TYPE AND LOCATION.
- 13. IN AREAS WHERE SOFT/LOOSE ZONES OR POSSIBLE VOIDS EXIST AT DEPTH, NOTIFY THE STRUCTURAL ENGINEER IMMEDIATELY. SUCH AREAS SHOULD BE UNDERCUT AND REPLACED WITH COMPACTED LOAD-BEARING FILL, OR FLOWABLE CONCRETE FILL AS DIRECTED BY THE DESIGN PROFESSIONAL. IN ADDITION, FOOTINGS SHOULD BE OVERSIZED AND PROPORTIONED FOR A REDUCED ALLOWABLE BEARING CAPACITY, AS DETERMINED BY THE STRUCTURAL ENGINEER, TO BETTER DISTRIBUTE FOUNDATION LOADS AND SPAN ANY LOCALIZED SOFT/LOOSE ZONE OR VOID AREAS.

CONCRETE NOTES

- REINFORCED CONCRETE CONSTRUCTION SHALL BE IN ACCORDANCE WITH ACI 318, LATEST EDITION
- 2. CONCRETE MATERIALS: FC = 4000 PSI FOR SLABS
 FC = 3000 PSI ALL OTHERS

CEMENT: ASTM CI50, TYPE I

AGGREGATE: ASTM C33 WATER: ASTM C94

EXTERIOR CONCRETE MIX: WATER CEMENT RATIO, 0.45 (AIR-ENTRAINED TO 4.5 % MIN)
INTERIOR CONCRETE MIX: WATER CEMENT RATIO, 0.50
PELNEOPCING MATERIALS.

3. REINFORCING MATERIALS:

REINFORCING BARS: ASTM A615, GRADE 60, DEFORMED

4. LAP SPLICES SHALL BE IN ACCORDANCE WITH THE FOLLOWING TABLE, UNLESS NOTED OTHERWISE. WHERE CLASSES ARE NOT CALLED OUT ON DRAWINGS, USE CLASS "B"

			COMPRESSION SPLICES (INCHES)			
	BAR	TOP	BARS	OTHER	BARS	
	SIZE	Α	В	Α	В	
	#3	16	21	12	16	12
	#4	21	28	16	21	15
	#5	27	35	21	27	19
	#6	35	46	27	35	23
	#7	48	62	37	48	26
	#8	63	82	48	63	<i>30</i>
5.	MINIMUM (CONCRETE CO	WFR SHALL	I BE PROVIDED F	OR REIN	FORCEMENT AS FOLLOWS:

5. MINIMUM CONCRETE COVER SHALL BE PROVIDED FOR REINFORCEMENT AS FOLLOWS
CAST AGAINST EARTH:
3" CLEAR
CONCRETE EXPOSED TO EARTH OR WATER: 2" CLEAR

ALL OTHER CONCRETE: 3/4" CLEAR

6. MINIMUM CONCRETE SLAB REINFORCEMENT SHALL BE AS FOLLOWS:


(PLACE ALL REINFORCING AND WWF 1/2" BELOW TOP OF SLAB WHERE APPLICABLE)

3~8" FLOOR SLAB ON METAL DECK 66-W2.0×W2.0
4" FLOOR SLAB ON GRADE 66-W2.0×W2.0
5" FLOOR SLAB ON GRADE 44-W4.0×W4.0

- 7. SLUMP OF CONCRETE FOR FOUNDATIONS SHALL NOT EXCEED 4" UNLESS A HIGH RANGE WATER-REDUCING ADMIXTURE IS USED. THE SLUMP OF CONCRETE FOR FOUNDATIONS PRIOR TO ADDITION OF A HIGH RANGE WATER REDUCING ADMIXTURE SHALL NOT EXCEED 4". THE SLUMP OF CONCRETE CONTAINING HIGH RANGE WATER-REDUCING ADMIXTURE SHALL NOT EXCEED 10".
- 8. COLD-WEATHER PLACING SHALL COMPLY WITH THE PROVISIONS OF ACI-306R. THE USE OF CALCIUM CHLORIDE, SALT, AND OTHER MATERIALS CONTAINING ANTI FREEZE AGENTS OR CHEMICAL ACCELERATORS SHALL NOT BE PERMITTED UNLESS OTHERWISE ACCEPTED IN THE MIX DESIGN.
- 9. HOT-WEATHER PLACING SHALL COMPLY WITH THE PROVISIONS OF ACI-305.

THIS DRAWING MUST BE USED IN CONJUNCTION WITH THE ARCHITECTURAL DRAWINGS



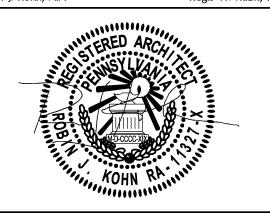

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> Contact Person: Edward (Kipp) Happ (610) 917-8831

PROJECT NO. DRAWN BY CHK'D BY RJK NO. DATE ISSUE SKETCH PLAN REVIEW 1 | 02-12-2016 | EMH SKETCH PLAN APPROVAL 2 | 02-19-2016 | EMH & PRFLIM PRICING PRELIM PERMIT REVIEW DRAWINGS 3 | 02-26-2016 | EMH ISSUED FOR PREMIT & CONSTRUCTION 4 | 04-08-2016 | EMH REVISED PER NEW CABINET LAYOUT CURRENT DATE APPROVED BY April 08, 2016 Robin J. Kohn, AIA

Schmitt & Malavolta Residence

1030 Hershey Mill Road West Chester, PA 19380

East Goshen Township Chester County

SHEET TITLE

FLOOR FRAMING PLAN, DETAILS & NOTES

SHEET NUMBER

S-1

4